PLANNING & DEVELOPMENT SERVICES DEPARTMENT

GAINE VILLE

every path starts with passion

FLORIDA

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TO:

City Plan Board

Item Number: 1

FROM:

Planning & Development Services Department

DATE: April 28, 2016

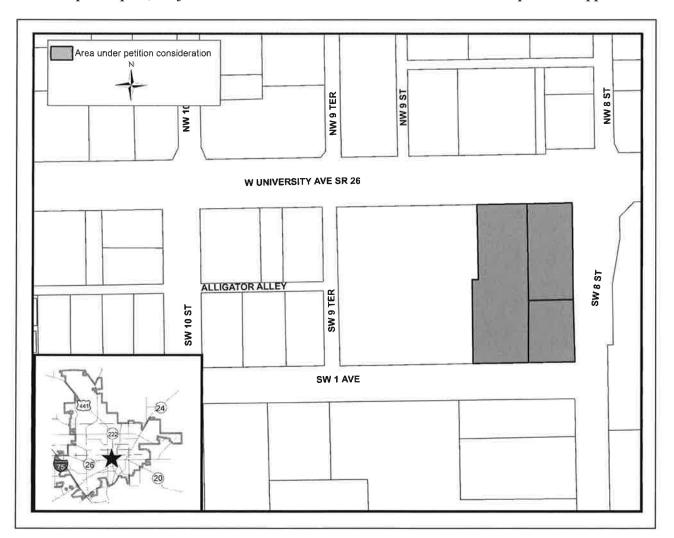
Staff

SUBJECT:

<u>Petition PB-16-25 SUP.</u> Causseaux, Hewett & Walpole, agent for TBG Innovation Square LLC, owner. Special Use Permit with development plan review to allow the construction of a mixed-use development. Zoned: UMU-2 (10-100 units/acre, and up to 25 additional units/acre by special use permit, urban mixed-use district). Located at 805-819 W University Avenue.

Recommendation

Approve the Special Use Permit (SUP), and also issue preliminary approval of the associated development plan, subject to the conditions and recommendations in this report and Appendix E.



Description

The applicant is requesting approval of a Special Use Permit (SUP) and an associated development plan to construct a six-story building that will contain retail space, an interior parking garage, and 110 dwelling units. Other proposed improvements include landscape material, signage, stormwater facilities, utilities, lighting, sidewalks, and vehicular and pedestrian connections. Signage, however, will be permitted separately.

The development site consists of three tax parcels that total .94 (MOL) acres. W University Avenue (SR 26) abuts on the north. SW 1st Avenue abuts on the south. SW 8th Street abuts on the east. A single tax parcel that contains a multi-story office building abuts on the west. The commercial and residential buildings that currently occupy the development site will be demolished.

The area surrounding the development site contains a mixture of residential, office and commercial uses. Innovation Square and the University of Florida main campus are within walking distance of the development site. The transportation facilities in the surrounding area include paved streets and sidewalks. Regional Transit System (RTS) bus routes are located on W University Avenue (SR 26) and SW 2nd Avenue, which has bike lanes. The surrounding area also has a mature tree canopy.

The development site and surrounding properties have Urban Mixed-Use 2 (UMU-2) land use and zoning designations, which allow a maximum of 100 dwelling units per acre by right, and up to 25 additional dwelling units per acre by Special Use Permit (see Exhibit A-1 and Exhibit B-1). The purpose of the SUP is to request additional dwelling units per acre beyond the 100 dwelling units per acre allowed by right in the UMU-2 zoning district. The property is .94 acres and would allow 94 dwelling units. The applicant is requesting 110 dwelling units for an overall density of 117 dwelling units per acre.

Key Issues

According to Section 30-65.2 - Urban mixed-use district 2 (UMU-2) of the City Land Development Code, the reviewing board is given authority to grant modifications to the UMU-2 zoning district regulations limited to the build-to-line, building relationship to the street, building articulation and design, landscape zone, sidewalk zone and streets/blocks standards, where the board finds by substantial competent evidence that:

- 1. The proposed development offers unique/alternative compliance that meets the intent of the UMU-2 zoning district; the requested modification is the minimum necessary to allow reasonable development of the site; and the requested modification is not injurious to the public health, safety and welfare; or
- 2. An undue hardship, owing to conditions peculiar to the land or structure and not the result of the action of the applicant, would result from strict adherence to the standard; or

3. The sidewalk zone or landscape zone cannot be constructed due to restrictions by the governmental entity responsible for the street where the sidewalk or landscaping is proposed. (See Exhibit B-1.)

The applicant is requesting board modifications to the UMU-2 zoning requirements, as stated in a letter labelled Exhibit C-2.

Basis for Recommendation

The staff recommendation is based on the criteria for issuance of a Special Use Permit (SUP) shown in Sec. 30-233 (see Exhibit B-2) of the City's Land Development Code. The Plan Board must make findings concerning the SUP to ensure that the design, location, and methods of operation of the proposed development conform to the City's Comprehensive Plan. Staff's findings for each of the criteria in Sec. 30-233 are as shown below.

Land Development Code, Sec. 30-233, Special Use Permit Criteria:

- 1. The proposed use or development complies with all required regulations and standards of Chapter 30 of the Land Development Code and all other applicable regulations. The City's Technical Review Committee finds the proposed use and development approvable, subject to the adoption of the conditions and recommendations provided in Appendix E.
- 2. The proposed use or development will have general compatibility and harmony with the uses and structures on adjacent and nearby properties. The City's Technical Review Committee finds the proposed use and development generally compatible and in harmony with the uses and structures on adjacent and nearby properties, provided the conditions and recommendations in Appendix E are adopted. This finding is based, in part, on the following: (1) The proposed retail space will consist of small specialty shops that generate fewer car trips than larger retail establishments; (2) Sidewalk and driveway connections will tie into existing transportation facilities in order to make pedestrian and vehicular circulation safe and efficient; (3) Bike and scooter parking spaces will be provided to support alternative modes of transportation and help reduce car trips; (4) An interior parking garage will help to reduce the demand for existing on-street parking spaces; (5) The proposed building complies with the UMU-2 maximum height requirement of 6 stories; (6) The brick and mortar proposed on the building exterior is consistent with adjacent buildings; (7) Lighting will be provided for visibility and to enhance security on the development site; (8) Landscape material will be provided to shade the adjoining streetscape and make it aesthetically pleasing; (9) Building wall articulation will be applied to all sides of the proposed building; and (10) The proposed building will be designed to reduce the view of rooftop mechanical equipment from other properties.

3. Necessary public utilities are available to the proposed site and have adequate capacity to service the proposed use and development. Comments from Gainesville Regional Utilities (GRU) in Appendix E indicate that further review is necessary to issue the proposed use and development final approval.

<u>CONDITION 1</u>: APPROVAL OF THE SPECIAL USE PERMIT (SUP) SHALL BE SUBJECT TO FINAL APPROVAL OF THE ASSOCIATED DEVELOPMENT PLAN AND THE ADOPTION OF THE CONDITIONS AND RECOMMENDATIONS IN APPENDIX E.

- 4. The use or development is serviced by streets of adequate capacity to accommodate the traffic impacts of the proposed use. The proposed use and development will occur within the University of Florida (UF) Context Area. Therefore, due to the proposed residential dwelling units, the applicant must sign a UF Context Area Agreement and make a payment to fund the capital transit costs associated with transit service needs. Although the proposed use and development is also within Zone A of the City's Transportation Mobility Program Area (TMPA), the applicant will not have to sign a TMPA agreement for trip generation.
- 5. Screening and buffers are proposed of such type, dimension and character to improve compatibility and harmony of the proposed use and structure with the uses and structures of adjacent and nearby properties. The City's Technical Review Committee finds the proposed use and development in compliance with the City's landscaping requirements, except as indicated in Appendix E. The proposed building will have parapets to screen rooftop mechanical equipment. Street trees will be provided along the abutting right-of-ways, as part of the public realm that is required in the UMU-2 zoning district. No screening or buffer is proposed along the west property line, since the allowed building setback is 0 feet.
- 6. The use or development conforms to the general plans of the City as embodied in the Gainesville comprehensive plan. The City's Technical Review Committee finds the proposed use and development consistent with applicable policies of the adopted comprehensive plan and land development code, except as noted in Appendix E. The proposed use and development is consistent with the intent of the UMU-2 land use and zoning categories, which is to provide compatible mixed-uses within close proximity to the University of Florida main campus and Innovation Square.
- 7. The proposed use or development meets the level of service standards adopted in the comprehensive plan and conforms to the concurrency management requirements of the Land Development Code as specified in Article III, Division 2. The City's Technical Review Committee finds the proposed use and development in compliance with the level of service standards and concurrency management requirements adopted by the City, except as noted in Appendix E.

Findings

The City's Technical Review Committee finds this petition approvable, subject to final approval of the associated development plan and the adoption of the conditions and recommendations provided in Appendix E. If approved, the Special Use Permit (SUP) is valid for a period of one (1) year from the date of Plan Board approval. Prior to the expiration of this one year period, the applicant must obtain a final development order for the associated development plan and obtain a valid building permit. Failure to comply with these requirements shall cause the approved SUP to become null and void unless, prior to the expiration date of the SUP, a request for an extension is approved by the Plan Board. A request to extend an SUP must be made through the City Planning Division prior to the expiration date.

Development Plan Review

The associated development plan requires a major level of review due to the applicant's proposal to construct a building consisting of 197, 279 (MOL) square feet. In addition to receiving an approved Special Use Permit (SUP), the applicant must also receive preliminary approval of the associated development plan from the Plan Board and final approval of the associated development plan from the City's Technical Review Committee (TRC). A copy of the associated development plan is provided in Appendix F.

Copies of the development application and documents discussing a neighborhood workshop held on January 28, 2016 are provided in Appendix D. A copy of the letter addressing the petition's compliance with the General Performance Standards in Section 30-345 of the City Land Development Code is labelled Exhibit C-1.

Conditions

1. Approval of the Special Use Permit (SUP) shall be subject to final approval of the associated development plan and the adoption of the conditions and recommendations provided in Appendix E.

Respectfully submitted,

Raph Hilland

Ralph Hilliard, Planning Manager

Prepared by:

Planner

Table 1

Adjacent Existing Uses

North	Commercial	
South	Vacant	
East	Office	
West	Office	

Table 2

Adjacent Zoning and Land Use

	Land Use Category	Zoning Category
North	UMU-2	UMU-2
South	UMU-2	UMU-2
East	UMU-2	UMU-2
West	UMU-2	UMU-2

List of Appendices

Appendix A Comprehensive Plan Goals, Objectives and Policies

Exhibit A-1: Future Land Use Element, Policy 4.1.1, Urban Mixed-Use 2 (UMU-2: 10 to 100 units per acre; and up to 25 additional units per acre by special use permit)

Appendix B Land Development Code

Exhibit B-1: Sec. 30-65.2. – Urban mixed-use district 2 (UMU-2) Exhibit B-2: Article VII, Division 5, SPECIAL USE PERMIT, Sec. 30.233 Special Area Plan for the Central Corridors Minimum Development Standards

Appendix C Supplemental Documents

Exhibit C-1: General Performance Standards Letter Exhibit C-2: Request for UMU-2 Board Modifications

Appendix D Application and Neighborhood Workshop Documents

Appendix E Technical Review Committee Conditions and Recommendations

Appendix F Development Plan

Appendix A

Comprehensive Plan Goals, Objectives and Policies





Urban Mixed-Use 1 (UMU-1: 8-75 units per acre; and up to 25 additional units per acre by special use permit)

This category allows a mixture of residential, retail, service and office/research uses. The Urban Mixed-Use districts are distinguished from other mixed-use districts in that they are specifically established to support research and development in the physical, engineering and life sciences in close proximity to the University of Florida main campus. An essential component of the district is orientation of structures to the street and multi-modal character of the area. Retail and office uses located within this district shall be scaled to fit into the character of the area. Residential density shall be limited to 75 units per acre with provisions to add up to 25 additional units per acre by special use permit. Lots that existed on November 13, 1991 and are less than or equal to 0.5 acres in size shall be exempt from minimum density requirements. All new non single-family principal buildings shall have a minimum height of 24 feet. Building height shall be limited to 6 stories. Land development regulations shall set the appropriate densities; the distribution of uses; design criteria; landscaping, and pedestrian/vehicular access.

Urban Mixed-Use 2 (UMU-2: 10 to 100 units per acre; and up to 25 additional units per acre by special use permit)

This category allows a mixture of residential, retail, service and office/ research uses. The Urban Mixed-Use districts are distinguished from other mixed-use districts in that they are specifically established to support research and development in the physical, engineering and life sciences in close proximity to the University of Florida main campus. An essential component of the district is orientation of structures to the street and multi-modal character of the area. Retail and office uses located within this district shall be scaled to fit into the character of the area. Residential density shall be limited to 10 to 100 units per acre with provisions to add up to 25 additional units per acre by special use permit. Lots that existed on November 13, 1991 and that are less than or equal to 0.5 acres in size shall by exempt from minimum density requirements. All new non-single-family principal buildings shall have a minimum height of 24 feet. Building height shall be limited to 6 stories and up to 8 stories by special use permit. Land development regulations shall set the appropriate densities; the distribution of uses; design criteria; landscaping, and pedestrian/vehicular access. Land development regulations shall specify the criteria for the siting of public and private schools, places of religious assembly and community facilities within this category.

Office

The Office land use category identifies areas appropriate for office and residential uses. This category is intended to identify appropriate areas for professional and service uses, hospital and medical uses, compound and residential uses, and appropriate ancillary uses. Office designations shall be applied to compact office development. Residential uses in office districts shall be designed as new in-town development, mixed-use, live-work, compound use or shall accommodate existing residential development within the district. Densities shall not exceed 20 units per acre. Land development regulations shall determine the appropriate scale of uses; and the specific criteria for the siting of private schools and churches. Intensity will be controlled by adopting land development regulations that establish height limits of 5 stories or less, that require

Appendix B

Land Development Code



Sec. 30-65.2. - Urban mixed-use district 2 (UMU-2).

- (a) Intent. The UMU-2 zoning district is created to promote and encourage redevelopment of the existing urban commercial areas and neighborhoods near the University of Florida. The district is intended to encourage multimodal mobility and to allow uses and development compatible with each other and with surrounding residential areas and which are consistent with the land use policies of the comprehensive plan. Furthermore, this district is intended to allow for establishments engaged in conducting research and experimental development in the physical, engineering or life sciences, in order to facilitate technology transfer from institutions of higher learning to the market place. The objectives of this district are to:
 - (1) Provide a mixture of residential, commercial and office/research uses that are complementary to the residential and mixed-use character of the district;
 - (2) Encourage quality redevelopment and the renovation of existing structures;
 - (3) Promote multimodal transportation and create high-quality urban streetscapes by using buildings, sidewalks, and street trees to form a pleasant, convenient and safe environment designed for pedestrians, bicyclists, public transit, and automobiles;
 - (4) Promote retail and office uses that serve the surrounding neighborhoods and enhance the viability of existing commercial areas by focusing new development in appropriate locations;
 - (5) Promote office/research uses that serve the needs of the University and the community and enhance the development of the local innovation economy; and
 - (6) Promote infill and redevelopment in the Urban Village to improve the urban form and increase mobility and interconnectivity by creating a gridded street network and sidewalk connections.

(b) Administration.

- (1) Required compliance. All development shall comply with these zoning district regulations except as otherwise provided by variance of the board of adjustment or by board modification, or administrative modification, as described below.
- (2) Modifications.
 - a. Board modification. The appropriate reviewing board shall have the authority to grant modifications limited to the build-to line, building frontage, building relationship to the street, building articulation and design, landscape zone, sidewalk zone and streets/blocks standards as are set forth in this section, where the board finds by substantial competent evidence that:
 - 1. The proposed development offers unique/alternative compliance that meets the intent of the UMU-2 zoning district; the requested modification is the minimum necessary to allow reasonable development of the site; and the requested modification is not injurious to the public health, safety and welfare; or
 - An undue hardship, owing to conditions peculiar to the land or structure and not the result of the action of the applicant, would result from strict adherence to the standard; or
 - The sidewalk zone or landscape zone cannot be constructed due to restrictions by the governmental entity responsible for the street where the sidewalk or landscaping is proposed.
 - b. Administrative modification. The city manager or designee shall have the authority to grant limited modifications, as set forth below, where the city manager or designee determines that the proposed development meets the intent of the UMU-2 zoning district, the requested modification is the minimum necessary to allow reasonable development of the site and the requested modification is not injurious to the public health, safety and welfare. Administrative modifications are limited to the following:

- Build-to lines: Modification not to exceed three feet beyond the required build-to line.
- 2. Glazing: Reduction of no more than ten percent of the required glazing.
- 3. First floor height: Reduction of no more than four feet of the required minimum height.
- 4. Sidewalk zones: Reduction of no more than two feet from the required width, provided that a minimum five feet of unobstructed width is maintained.
- 5. Landscape zones: Reduction of no more than one foot from the required width, provided that the required root space is allocated for street trees.
- 6. Building frontage: Allowance of insets in the building façade for the purpose of providing pedestrian forecourts, courtyards, plazas, cafes or other public outdoor gathering areas. The allowance for the inset may be up to 20 feet in length and greater than five feet in depth and up to ten feet in depth. In addition, insets for high quality heritage trees may be allowed up to the required area to protect the tree.
- c. In granting a modification, the reviewing board or administrator may impose any reasonable additional conditions, restrictions or limitations deemed necessary or desirable by the board or administrator to preserve and promote the intent of the UMU-2 zoning district.
- d. All requests for modifications shall be submitted in writing with the application for development review on forms provided by the city. The request shall be approved or denied during development plan review and, if granted, shall be noted on the final development plan. If denied, there is no further administrative appeals process.
- (3) Effect of regulations. Where this section specifically addresses a requirement and it is in conflict with other provisions of this land development code, the requirement of this section shall govern. Where this section does not specifically address a requirement, the applicable provisions of the land development code shall apply.
- (4) This zoning district applies only to land zoned UMU-2 and located within the University Heights, Archer Triangle, and Urban Village areas. These areas are depicted in Figures 1.0, 1.1 and 1.2.
- (5) All figures referenced in this section are located at the end of this section.

(c) Uses.

(1) Permitted uses by right are as follows:

SIC	Uses	Conditions
	Compound uses	
	Single-family dwellings	
	Rowhouses	
	Multi-family dwellings	Minimum and maximum densities are set forth in the Dimensional Requirements Table in this section
	Incidental residential accessory uses, including	

storage rooms, management offices, club or game rooms, and recreational and laundry facilities intended for use solely by the residents of the developments and their guests	
Dormitory	Must not abut property designated single-family on the future land use map
Rooming houses and boarding houses	In accordance with article VI
Consolidated apartment management offices	
Bed and breakfast establishment	In accordance with article VI
Community residential homes with 14 or fewer residents	When part of a permitted single-family or multi- family residential development and in accordance with article VI
Community residential homes with more than 14 residents	In accordance with article VI
Adult day care homes	In accordance with article VI
Family day care homes	In accordance with article VI
Day care center	In accordance with article VI
Places of religious assembly	In accordance with article VI
Public service vehicles	In accordance with article VI
Outdoor cafes	In accordance with article VI
Eating places	
Food trucks	In accordance with article VI
Repair services for household needs	
Specialty T-shirt production	

	Structured parking	In accordance with subsection (f)(3) below		
	Rehabilitation centers	In accordance with article VI		
	Research and development in the physical, engineering and life sciences			
	Light assembly, packaging, and manufacturing associated with research and development in the physical, engineering and life sciences			
	Chilled water and steam plants, electric generation, and other energy storage, distribution, and conversion facilities			
	Scooter sales	Only within enclosed buildings in accordance with section 30-67(g). Facilities to service scooters are permitted as an accessory use when such facilities do not exceed 45% of the gross floor area of the enclosed building.		
GN- 074	Veterinary services	Only within enclosed buildings and in accordance with article VI		
GN- 078	Landscape and horticultural services			
MG- 43	U.S. Postal Service			
GN- 471	Arrangement of passenger transportation	Offices only, with no operation of passenger tours on site		
GN- 483	Radio and television broadcasting stations	Accessory transmission, retransmission, and microwave towers up to and including 100 feet in height in accordance with article VI, excluding cellular telephone services		
GN- 523	Paint, glass, and wallpaper stores			

GN- 525	Hardware stores	
GN- 526	Retail nurseries, lawn and garden supply	
MG- 53	General merchandise stores	
MG- 54	Food stores	Excluding gasoline pumps
MG- 56	Apparel and accessory stores	
MG- 57	Home furniture, furnishing, and equipment stores	
MG- 59	Miscellaneous retail	Excluding GN-598 Fuel Dealers
Div. H	Finance, insurance and real estate	Excluding cemetery subdividers and developer (IN-6553)
Div.	Public administration	Excluding correctional institutions (IN-9223)
MG- 72	Personal services	Including funeral services and crematories in accordance with article VI and excluding industrial laundries (IN-7218)
MG- 73	Business services	Excluding outdoor advertising services (IN-7312), disinfecting and pest control services (IN-7342), heavy construction equipment rental and leasing (IN-7353), and equipment rental and leasing, not elsewhere classified (IN-7359)
GN- 701	Hotels and motels	

MG- 78	Motion picture	
MG- 79	Amusement and recreation services	Excluding go-cart rental and raceway operations, commercial sports, and simulated gambling establishments. Must be located within enclosed structures.
MG- 80	Health services	
MG- 81	Legal services	
MG- 82	Educational services	
MG- 83	Social services	
MG- 84	Museums, art galleries, and botanical and zoological gardens	
MG- 86	Membership organization	
MG- 87	Engineering, accounting, research, management, and related services	

(2) Permitted uses by special use permit are as follows:

SIC	Uses	Conditions
	Alcoholic beverage establishments	In accordance with article VI
	Surface parking (as a principal use)	Only within the University Heights District and in accordance with subsection (f)(3) below

- (3) Prohibited uses: Single-story, large-scale retail uses (defined as a single retail use with a ground floor footprint exceeding 100,000 square feet) are prohibited in the Urban Village.
- (4) Drive-through facilities: Drive-through facilities are prohibited in this district except fronting on SW 34th Street in the Urban Village. Access to a drive-through facility fronting on SW 34th Street may be from another street or from an internal system within a mixed use development. A special use permit is required for all drive-through facilities in the Urban Village. Drive-through facilities are defined as facilities that provide services mechanically or personally to customers who do not exit their vehicles, examples include, but are not limited to, banking facilities, payment windows, restaurant, food and/or beverage sales, dry cleaning and express mail services. The following are not considered drive-through facilities: auto fuel pumps and depositories which involve no immediate exchange or dispersal to the customer, such as mail boxes, library book depositories, and recycling facilities.
- (d) Site development requirements.
 - (1) All structures shall be located and constructed in accordance with the Dimensional Requirements Table. Accessory structures shall meet all regulations pertaining to principal structures within this district.

Dimensional Requirements Table

	Nonresidential and Vertically Mixed Use Buildings	Single-Family Dwellings	Multi-Family Dwellings, Two-Family Dwellings and Rowhouses
Lot depth (minimum)	90 feet	90 feet	90 feet
Interior side (minimum)	O feet, or 25 feet when abutting property designated single-family or residential low-density on the future land use map	5 feet except that, where adjoining lots are developed at the same time under single ownership, one side of each lot may have no yard setback if the setback for the adjoining yard is at least 10 feet	7.5 feet, or 25 feet when abutting property designated single-family or residential low- density on the future land use map
Rear (minimum)	O feet, or 25 feet when abutting property designated single-family or residential low-density on the future land use	10 feet	5 feet, or 25 feet when abutting property designated single-family or residential lowdensity on the future land use

	map.		map.
Lot coverage (maximum)	N/A	N/A	80%
Building frontage ¹	70% minimum	N/A	70% minimum
Density (minimum) ²	Within University Heights and the Archer Triangle, N/A	N/A	Within University Heights and the Archer Triangle, 10 du/acre
	Within the Urban Village, to be considered mixed-use, a residential development must include a minimum of 10,000 square feet of nonresidential uses; and a nonresidential development must contain a minimum of 3 residential units.		Within the Urban Village, 20 du/acre for new, single-use multi-family development; 10 du/acre for mixed use developments and additions to existing developments.
Density (maximum)	Within University Heights and the Archer Triangle, 100 du/acre, or up to 125 du/acre by special use permit.	N/A	Within University Heights and the Archer Triangle, 100 du/acre, or up to 125 du/acre by special use permit.
	Within the Urban Village, 100 du/acre by right; or up to 125 du/acre by special use permit, except that 125 du/acre is allowed by right when only structured parking and/or on- street parking is provided (except for handicapped accessible surface parking)		Within the Urban Village, 100 du/acre by right; or up to 125 du/acre by special use permit, except that 125 du/acre is allowed by right when only structured parking and/or onstreet parking is provided (except for handicapped accessible surface parking).
Height and Stories	Non-single-family build	dings shall have a m	ninimum height of 24 feet.
	A maximum of six stories is permi	tted by right. Unles	ss otherwise specified, a maximum of

	eight stories is permitted by special use permit in all areas except the Power District.
(Ex	Within the Urban Village, a maximum of eight stories is permitted by right when only structured and/or on-street parking is provided (except for handicapped accessible surface parking spaces for multi-family development and loading spaces for nonresidential development).
	Within University Heights, a maximum of three or four stories for a distance of 50 feet as measured from the property line of properties located adjacent to the University Heights Historic Districts, as depicted in Figure 3.0.
	Within the Power District, a maximum of three stories is permitted at the build-to line when located adjacent to residentially zoned properties as depicted in Figure 3.1, with a step back of 15 feet per additional building story up to the maximum permitted.

Notes to Table:

¹ Minor insets (defined as up to five feet in depth) for the purpose of creating articulation and architectural interest in the building façade will be deemed to meet the build-to line and shall be included in computing the building frontage.

² Within University Heights and the Archer Triangle, lots that existed on November 13, 1991 and that are less than or equal to 0.5 acres in size are exempt from the minimum density requirements. Within the Urban Village, lots that existed prior to 12:01 a.m. on June 1, 2009 and that are less than 0.5 acres in size are exempt from the minimum density requirements.

⁽²⁾ Building relationship to the street or urban walkway. Urban walkways are allowed only in the Urban Village as set forth in section 30-65.2(e)(3)d.

a. All principal nonresidential buildings are required to have a main entrance facing the street or an urban walkway. If a building fronts both a street and an urban walkway, the main entrance shall face the street. A main entrance shall be indicated on building floor plans by the placement of atriums, lobbies, or other entry rooms at the entrance and through the inclusion of architectural entry features such as, but not limited to, awnings, arcades, columns or archways, and by providing a level of architectural detailing that is comparable to or exceeds other entrances to the building.

Two-family dwellings and rowhouse residential units on the first story shall have a functional entrance on the street or on an urban walkway.

c. For nonresidential and multiple family residential (except for two family dwellings and rowhouses) buildings, the façade fronting a street or an urban walkway shall have a functional entrance at least every 150 feet.

d. Sidewalk connections to the public sidewalk must be provided from all building entrances that face the street or an urban walkway. These connections shall provide at least five feet of unobstructed width.

- e. Front porches or covered stoops for multi-family uses.
 - Two-family dwellings and rowhouse residential units on the first floor along a street or urban walkway shall have individual front porches or covered stoops.
 - 2. Front porches or covered stoops shall have a minimum surface area of 25 square feet with a minimum depth of five feet and a minimum width of five feet.
 - 3. Front porches or covered stoops shall be open and not air conditioned.
 - 4. Front porches may only be screened where they are located behind the build-to line.
- f. Except for a driveway to reach the side yard or rear yard or on-site parking, neither driveways nor surface parking lots are permitted between the sidewalk and a building or between an urban walkway and a building. Driveways shall be perpendicular to any adjacent street. In the Urban Village, porte cocheres or covered drop-off areas in front of a building may be allowed for hotels, medical facilities, nursing homes, or assisted living facilities. Porte cocheres or covered drop-off areas shall be designed to meet queuing requirements such that vehicular traffic does not overflow out on public streets or sidewalks and does not impede safe and convenient pedestrian circulation at the site.
- (3) Building articulation and design.
 - a. Glazing. As depicted in Figure 7.0, glazing percentages are calculated by measuring the area of glazing between three feet and eight feet above grade, and dividing it by the total area of the building façade between three feet and eight feet above grade. Required glazing must be at least 80 percent transparent and shall not utilize painted glass, reflective glass or other similarly treated windows. Glazed areas on entrances may be counted towards meeting the minimum glazing requirements.
 - 1. For multi-family residential uses, the minimum glazing percentage shall be 30 percent for the first story and 20 percent for upper stories, on all street frontages or urban walkways.
 - 2. For nonresidential uses, minimum glazing percentage shall be 50 percent for the first story on local and urban throughway street frontages and all street frontages in the Urban Village, and 65 percent for the first story on storefront street and principal street frontages. In the Urban Village, nonresidential buildings fronting on an urban walkway shall have a minimum glazing percentage of 50 percent for the first story.
 - b. Delineation of stories. The area between the first and second stories along all street frontages shall include architectural detailing, such as, but not limited to, variations in materials or horizontal expression lines, to visually delineate the first and second stories.
 - c. First floor height. All multi-story buildings on storefront streets shall have a minimum first story floor-to-floor height of 15 feet.
 - d. First floor uses. On principal and storefront streets, buildings shall be designed so that the area of the first floor along the street frontage contains active uses that are oriented to the street. Active uses may include, but are not limited to, display or floor areas for retail uses, waiting and seating areas for restaurants, atriums or lobbies for offices, and lobbies or dining areas for hotels or multifamily residential buildings. Residential units shall not be located directly on the first floor street frontage of buildings on storefront streets.
- (e) Public realm requirements.
 - (1) Existing streets. The street types referred to throughout this section (local street, principal street, storefront street and urban throughway) are identified and depicted in Figure 2.0 and Figure 2.2.
 - (2) Primary frontage streets. Within the Urban Village, primary frontage streets are identified and depicted in Figure 2.3. All buildings with multiple street frontages shall orient the main entrance and the front face to the primary frontage street. If a building fronts both SW 34th Street and

another primary frontage street, the main entrance and the front face shall be oriented toward SW 34th Street. In the case of corner lots, corner entrances that front both streets are allowed.

(3) New streets/blocks.

- a. Within the University Heights area, subdivisions, minor subdivisions, lot splits, and development that requires development plan review shall be required to include new local streets so that the resulting block(s) will not exceed a maximum block perimeter of 2,000 feet
- b. Within the Archer Triangle area, subdivisions, minor subdivisions, lot splits, and development on sites greater than two acres which propose new development on more than 50 percent of the site shall be required to include new local streets within the subdivision, minor subdivision, lot split or development so that the resulting block(s) will not exceed a maximum block perimeter of 2,600 feet.
- c. Within the Urban Village area, subdivisions, minor subdivisions, lot splits, and development on sites greater than two acres which propose new development on more than 50 percent of the site shall be required to include new local streets within the subdivision, minor subdivision, lot split or development so that the resulting block(s) will not exceed a maximum block perimeter of 2,000 feet.
- Within the Urban Village area, an urban walkway may be used to meet the block perimeter requirements, subject to city approval. An urban walkway is a pedestrian/bicycle pathway that is either: a minimum width of 30 feet with a single contiguous paved area of at least ten feet or a minimum width of 31 feet with a separated (boulevard style) paved area with a minimum contiguous paved area of eight feet on one side and five feet on the other side. Urban walkways must provide a minimum eight-feet landscape zone area on each side of the paved area. Unpaved areas in an urban walkway must be landscaped and may contain stormwater facilities. Urban walkways may contain benches, fountains, outdoor cafes or other outdoor uses as long as a minimum sidewalk width as specified above is maintained. Cross-sections for urban walkways must be submitted as part of a required circulation plan or as part of a development plan when a circulation plan is not required. The cross-section must illustrate paved area, landscape zone, build-to line and any outdoor uses. An urban walkway may be used as an interim/temporary method for retaining the required area for a future street when an abutting development/redevelopment occurs. In this case, the total width may be reduced to 25 feet, while maintaining a contiguous minimum paved width of ten feet. The width and cross-section of the urban walkway is subject to review and approval by the city to ensure that future street construction can occur in the area provided. If the urban walkway will be a permanent area, it may be used to count toward meeting open space requirements even if it is later dedicated as a public urban walkway. Notwithstanding the foregoing, in the case where an urban walkway provides access for fire and rescue vehicles, stormwater management, utilities or other public facilities and services, the urban walkway shall be sized and designed to meet the requirements for those facilities and services.
- e. The required local streets, multi-use paths or urban walkways shall be constructed at the expense of the owner/developer as part of the subdivision, minor subdivision, lot split or development, to serve the subdivision, minor subdivision, lot split or development, and shall be constructed according to the appropriate city standards as determined through the development review, subdivision, minor subdivision or lot split process, but may be sited and configured in a manner so that they provide the most appropriate access to the development, subdivision, minor subdivision or lot split. Where a street is planned to continue beyond the extent of a development, subdivision, minor subdivision or lot split, the development shall provide for the continuation of the street by stubbing out the improvements as close as is practicable to edge of the property boundary.

The required local streets or multi-use paths or urban walkways may be dedicated for public right-of-way after construction, if the city desires to accept same for maintenance, or

may be privately owned streets, multi-use paths or urban walkways provided the streets, multi-use paths or urban walkways remain open for public ingress and egress.

- f. Notwithstanding any other provision in this chapter, a subdivision, minor subdivision, lot split, or development may receive final approval prior to construction of the required local streets if the city, upon approval of the city commission, has executed a binding agreement with the owner/developer that:
 - Requires the city and/or the Gainesville Community Redevelopment Agency to construct the required local streets as public streets within two years of final approval; and
 - 2. Provides for the conveyance or dedication of the associated right-of-way from the property owner to the city, at no cost to the city.

The city may enter into such an agreement only when the city determines that doing so would be in the public interest and when the city and/or the Gainesville Community Redevelopment Agency has budgeted legally available funds for the construction of the required local streets. The form and content of the agreement shall be provided by and acceptable to the city in its sole discretion.

g. Board modifications may be granted in accordance with section 30-65.2(b)(2)a., with specific consideration given to situations where the construction of a street is limited by: access management standards, regulated environmental features, regulated natural or archeological resources, public stormwater facilities, existing utility facilities, contamination sites, inconsistencies with plans for a future city street network, parks, or schools. Where it is determined that it is not possible to construct the streets that would be required to meet block perimeter standards, the block perimeter shall be completed with the provision of sidewalk and bicycle connections or multi-use paths or urban walkways, subject to approval by the city.

(4) Sidewalk zone.

- a. The minimum sidewalk dimensions are set forth in the Streetscape Dimensions Table.
- b. The sidewalk zone shall be continuous and entirely hardscaped by the owner/developer and shall be immediately contiguous to the landscape zone.
- c. Outdoor seating may encroach into the sidewalk zone provided that a minimum unobstructed width of five feet is maintained.
- d. Balconies, marquees, projecting signs, and awnings may encroach into the sidewalk zone up to a distance of half the required sidewalk dimension, provided that they are at least nine feet above the grade of the sidewalk.
- e. The owner/developer shall construct new sidewalks to align with existing sidewalks on abutting properties.

(5) Landscape zone.

- a. There shall be a continuous landscape zone adjacent to the curb which shall meet the dimensions set forth in the Streetscape Dimensions Table. This zone allows the placement of street trees, street furniture and light poles, fire hydrants, traffic signs, bus shelters, bicycle racks, litter receptacles, benches and similar items. In the Urban Village, street trees in the landscape zone may not intrude into the public right-of-way without approval from the governmental entity responsible for the public road.
- b. The owner/developer shall install street trees to meet the spacing requirements set forth in the Streetscape Dimensions Table. All street trees shall be provided a minimum of 140 square feet of root room to a depth of three feet, and shall be planted no closer than ten feet from any building or wall foundation.

- c. The area of the landscape zone between trees shall be hardscape on storefront streets and principal streets. Hardscape is optional for streets with on-street parking. Street trees shall be planted within a landscaping or grass strip on local streets, urban throughway streets, and all streets in the Urban Village. In the Urban Village, a board modification to allow hardscape within the landscape zone may be requested. Surface openings for trees within tree wells shall be at least 18 square feet. Landscaping utilized between street trees should not exceed 30 inches at mature height.
- d. Where heritage trees are located within the public right-of-way they should be preserved and no new construction placed within the tree root plate. New buildings should be designed so that no more than 25 percent of the crown of these preserved trees is removed. The removal, relocation or replacement of heritage trees shall be in accordance with section 30-258 of the land development code.
- e. Street trees shall meet state department of transportation clear zone requirements, adopted pursuant to F.S. Ch. 316 and adopted by reference in chapter 26 of this Code. A visual example is provided in Figure 6.1, Streetscape with Four-Foot Clear Zone.

(6) Build-to line.

- a. The build-to line shall be measured from the back of curb. Except that, in the Urban Village, the build-to line shall be measured from the property line on swale system streets and from the back edge of the landscape zone on urban walkways.
- b. The build-to-line shall be calculated as the sum of the required landscape zone, sidewalk zone and required setback from the sidewalk zone. Except that, on urban walkways, the build-to line shall be a fixed five feet from the back edge of the landscape zone.
- c. The build-to line standards of this section shall not result in structures being built in the public right-of-way. If the build-to line dimensions result in a build-to line within the public right-of-way, the actual build-to line shall be established at the property line adjacent to the public right-of-way.
- (7) Transit facilities. Transit stop facilities shall be within the landscape zone or sidewalk zone or right-of-way and located in accordance with the most current "Regional Transit System Bus Stop Improvement Plan" on file with the Regional Transit System.

Streetscape Dimensions Table

	Urban Throughway and SW 34th Street	Storefront streets	Principal streets	Local streets or private streets ¹	Swale system streets	SW 24 th Avenue
Landscape zone (minimum)	8 feet	5 feet	5 feet	8 feet	8 feet	8 feet
Street tree spacing	35 feet (minimum) to 50 feet (maximum),	35 feet (minimum) to 50 feet (maximum),	35 feet (minimum) to 50 feet (maximum),			

	on center	on center	on center	on center	on center	on center
Sidewalk zone (minimum)	8 feet	10 feet	10 feet	10 feet	8 feet	8 feet
Build-to-line (nonresidential uses)	25-80 feet setback from the back of curb	20 feet setback from the back of curb	20 feet setback from the back of curb	18 feet setback from the back of curb	15-25 feet setback from the back of right-of-way	20-25 feet setback from the back of curb
Build-to line (residential uses)	30-80 feet setback from the back of curb	20 feet setback from the back of curb	25 feet setback from the back of curb	23 feet setback from the back of curb	15-25 feet setback from the back of right-of-way	25-30 feet setback from the back of curb

Note to Table:

Examples of the landscape zone, sidewalk zone and streetscape scenarios are depicted in Figures 4.0—4.3, Public Realm Requirements and Figure 6.0, Streetscape Scenarios.

Urban Walkway Dimensions Table ¹

Overall Width	Paved Area	Landscape Zone	Build-to Line
30 feet (minimum) for single; 31 feet (minimum) for split boulevard style	10 feet (minimum) for single; or 8 feet (minimum) and 5 feet (minimum) for split boulevard style	8 feet (minimum)	5 feet from back edge of landscape zone

¹ Newly constructed local or private streets shall be curb and gutter unless otherwise approved by the city's public works department.

¹ Notwithstanding the standards set forth in this table, in the case where an urban walkway provides access for fire and rescue vehicles, stormwater management, utilities or other public facilities and services, the urban walkway shall be sized and designed to meet the requirements for those facilities and services.

- (f) Additional requirements.
 - (1) Circulation plan.
 - Applicability. All new development or redevelopment on more than 50 percent of development sites in the Urban Village that is greater than two acres in size (including all contiguous lots/parcels) shall submit a circulation plan for the site. Abutting property owners or multiple property owners may submit a binding joint circulation plan that establishes the future circulation system (including bicycle, pedestrian, motorized vehicle, and transit) for a specified area. The joint circulation plan shall provide for all necessary cross-access agreements, deed restrictions, land reservations, or other methods necessary to implement the circulation plan and ensure cross-connectivity that runs with the land. The circulation plan shall be submitted as:
 - 1. A preliminary plan approved by the appropriate reviewing board to guide future development on the site;
 - 2. Part of an application for development plan or planned development rezoning;
 - 3. Part of a master plan (as defined in section 30-161) for phased developments; or
 - 4. Part of a subdivision, minor subdivision, or lot split application.
 - b. Contents. The circulation plan shall illustrate:
 - The perimeter block size for the proposed development area;
 - 2. Proposed new street or urban walkway locations;
 - 3. General location of developed areas, future phases, and open space;
 - 4. The connection points to abutting properties including stub-outs where the abutting property is either undeveloped or contains development that presents an impediment to connectivity;
 - 5. The access point(s) to the existing external roadway network;
 - 6. Location of proposed stormwater facilities;
 - 7. Known, regulated environmental features or regulated natural or archeological resources;
 - 8. Location of existing or proposed transit stops and connections to transit stops;
 - 9. Street and/or urban walkway cross-sections including locations of on-street parking, landscape zone, bike paths, sidewalk zone, paved area, and the build-to line;
 - 10. Compliance with the primary frontage street requirements; and
 - 11. A street frontage hierarchy for new streets in the development to identify where principal building entrances will be located.
 - c. Review, expiration, and amendment of a circulation plan. The circulation plan is subject to review and approval by the appropriate reviewing board or by staff when only subject to staff review. A circulation plan shall be valid for the period of a development plan, PD, or other final development order when part of another review. Alternatively, if the circulation plan is a stand-alone plan, it shall be valid for a period of five years unless otherwise specified. The circulation plan expiration date may be extended prior to expiration for good cause with city approval. A circulation plan may be amended by the appropriate reviewing board or by staff when only subject to staff review to account for changed conditions at the site or in the proposed street network in the Urban Village.
 - (2) Landscape buffers. All development in this district is exempt from the general landscape buffer requirements in article VIII of the land development code.

- (3) Parking. Other than as required by the Americans with Disabilities Act (ADA) and Florida Accessibility Code (FAC) or other state or federal requirements, there shall be no minimum vehicular parking requirement in University Heights and Archer Triangle. In the Urban Village, the minimum vehicular parking requirement is one space per residential unit and one-half of the required parking for nonresidential uses as provided in the land development code. Scooter parking shall be provided for residential uses at a rate of one space for every four residential units.
 - a. Surface parking (as an accessory use).
 - There shall be a maximum vehicular surface parking allowance of one parking space per 400 square feet of gross floor area for nonresidential uses. There shall be a maximum of one surface parking space per unit for multi-family in the Urban Village. However, there shall be no limit on the number of parking spaces provided in the form of structured parking for residential or nonresidential uses.
 - Surface parking shall be located in the rear or interior side of the building.
 - 3. Surface parking adjacent to streets shall meet the standards depicted in Figure 5.0, Parking Exhibit. Surface parking adjacent to primary frontage streets in the Urban Village shall meet the standard for principal streets. All other streets in the Urban Village shall meet the standard for local streets.
 - 4. Surface parking lots shall comply with the landscaping requirements in article VIII of the land development code.
 - b. Surface parking (as a principal use). In addition to the special use permit regulations found in Article VII, Division 5, Special Use Permit, this subsection provides additional regulations for surface parking as a principal use within the University Heights Area. If provisions in this subsection conflict with the provisions in Article VII, Division 5, the provisions in this subsection shall prevail.
 - 1. Surface parking shall be permitted only when the surface parking will be replaced with either a building or structured parking in accordance with an approved master plan.
 - 2. Surface parking shall be paved.
 - 3. Surface parking shall have either perimeter landscaping in accordance with the landscape regulations as provided in this land development code or perimeter garden walls that create a visual buffer, are at least 25 percent opaque, and do not exceed a height of 72 inches.
 - 4. Surface parking shall be in compliance with all lighting and stormwater regulations in this land development code.
 - 5. Any special use permit approved pursuant to this subsection shall be valid for a period not to exceed five years. The city plan board may extend a special use permit approved under this section for an additional period not to exceed five years if the applicant demonstrates that development in accordance with the approved master plan has commenced.

c. Structured parking.

- 1. Shall not be located within 100 feet of property designated for single-family use on the future land use map.
- Structured parking shall provide architectural detailing on the first and second stories, such as, but not limited to, variations in materials, framing of wall openings, vertical or horizontal expression lines, pilasters, arches, or railings.
- 3. Automobiles shall be screened from street view by wall, fence or vegetative matter.
- 4. Structured parking adjacent to streets shall meet the standards depicted in Figure 5.0, Parking Exhibit. Within the Urban Village, structured parking on primary frontage

streets shall meet the standard for principal streets as depicted in Figure 5.0 including the provision of a minimum of 20 feet of active uses on the first floor.

d. Bicycle parking.

- The owner/developer shall provide a minimum of one space per 2,000 square feet of gross floor area for nonresidential uses and one space per three bedrooms for residential uses for bicycle parking.
- 2. A minimum of ten percent of the provided bicycle parking shall be located between the building and the street. The remainder shall be located a maximum distance of 100 feet from a building entrance and shall be covered from inclement weather or located within an accessory parking structure.
- e. Vehicular access. Developments may have one curb cut located on each street frontage, except that curb cuts shall not be permitted on storefront or principal streets when access may be provided from a local street or alley.

(4) Loading areas and dumpsters.

- a. Loading docks shall be prohibited along storefront streets, principal streets, urban throughway streets, and all non-local streets in the Urban Village. If a development has access/frontage only on a storefront or principal street and it is infeasible to provide an alley or other rear loading area on the site, the loading dock must be located in the most unobtrusive location and fully screened from street and sidewalk view.
- b. Loading dock entrances along the street shall be screened with automatic doors so that the dock and related activities are not visible from the adjacent sidewalk.
- c. Dumpsters shall be placed at the side or the rear of the building so that they are not visible from the street.
- d. Dumpsters shall be surrounded by an enclosing wall that is attached to a building. The enclosing wall shall not exceed eight feet in height, and shall be finished or painted with the same material or color as the building. The enclosing wall shall be fitted with an opaque sliding or hinged door and working latch.

(5) Walls and fences.

- Fences made of chain-link (wholly or in part) are prohibited.
- b. The maximum height of fences or walls shall be 40 inches when located within a front or side yard and 72 inches when located within a rear yard.

(6) Mechanical equipment.

- a. Mechanical equipment shall not be permitted between any building and storefront, urban throughway or principal streets or any non-local street in the Urban Village.
- b. Screening (by wall, fence or vegetative matter) that exceeds the height of the equipment shall be required if the equipment is visible from the street or adjacent properties. Certain equipment, such as but not limited to, rain barrels or cisterns, shall not require screening provided they are designed to blend with the building and are constructed with the same materials and colors.
- c. Chiller plants and similar utility structures.
 - 1. Chiller plants and similar utility structures shall not be permitted between any building and storefront street, principal street or any non-local street in the Urban Village.
 - 2. Chiller plants and similar utility structures shall provide a minimum 15-foot landscape strip planted with shrubs and trees between the structure and the street or abutting properties.

3. Opaque walls a minimum of six feet in height shall be provided between the structure and the public street.

(7) Signage.

- a. Signs shall be externally lit. Individual letters and symbols may be internally lit or back-lit.
- b. Finish materials shall consist of one or more of the following:
 - Wood (painted or unpainted); or
 - 2. Metal (painted or unpainted); or
 - 3. Painted or rubberized canvas; or
 - 4. Strip lighting with the appearance of neon (including individual channel letter signs that are internally illuminated and may have plastic faces); or
 - 5. Engraving directly on the facade surface; or
 - 6. Wood-like materials; or
 - 7. Lettering on transparent windows or doors; or
 - 8. Vinyl lettering with a painted appearance.

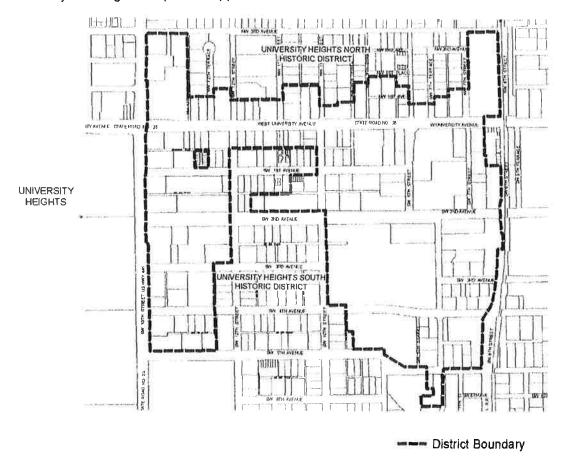


Figure 1.0 District Boundary Map—University Heights

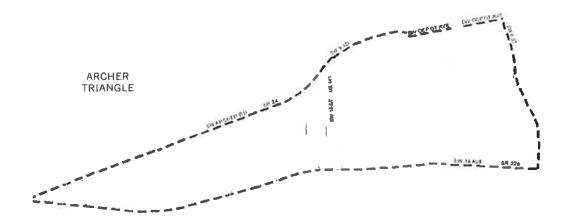


Figure 1.1 District Boundary Map—Archer Triangle

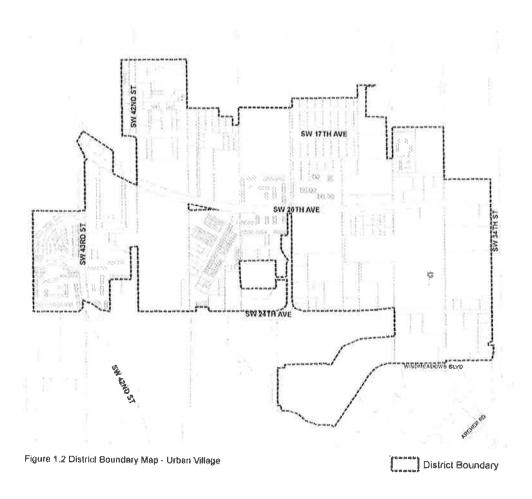


Figure 1.2 District Boundary Map—Urban Village

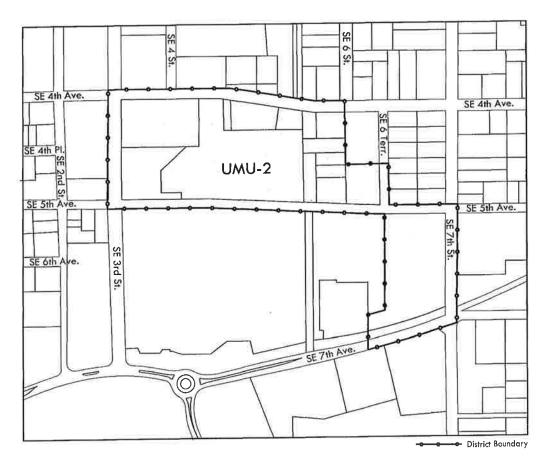


Figure 1.3 District Boundary Map—Power District

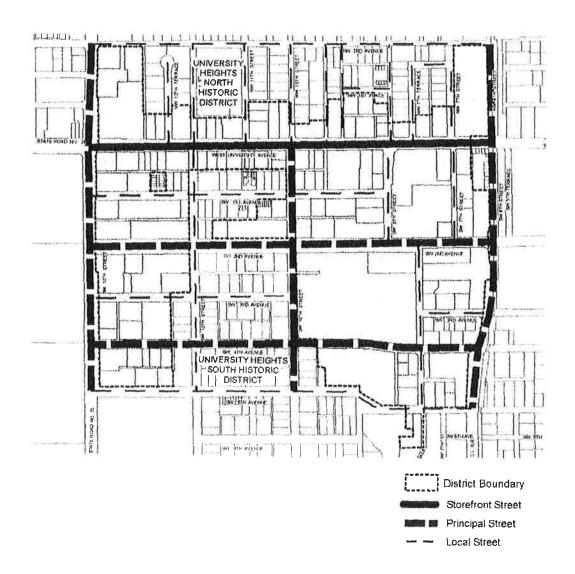


Figure 2.0 Street Types—University Heights

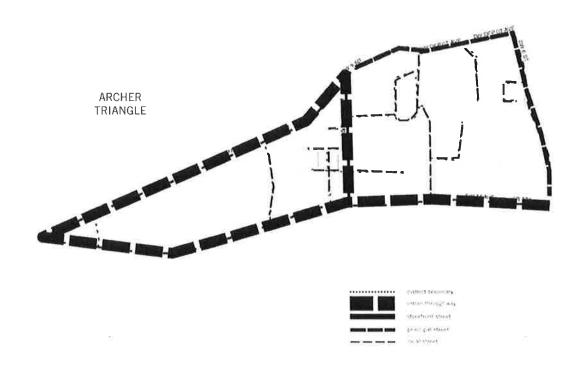


Figure 2.1 Street Types—Archer Triangle

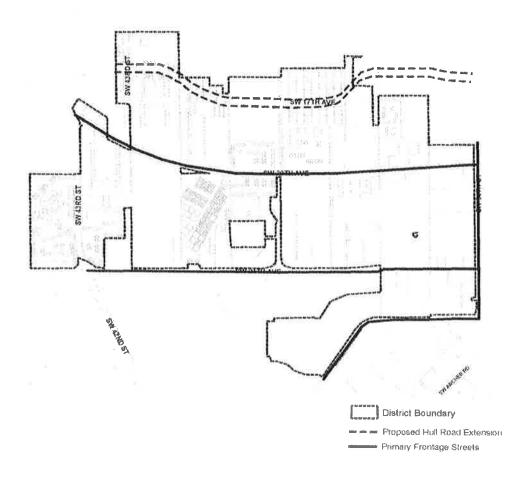


Figure 2.2 Primary Frontage Streets—Urban Village

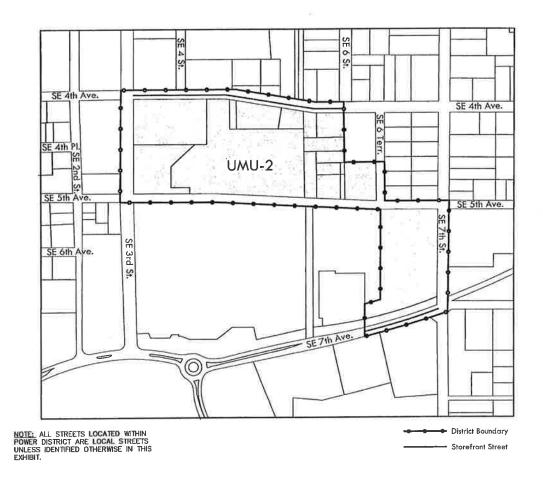


Figure 2.3 Street Types—Power District



Figure 3.0 Height Limits—University Heights

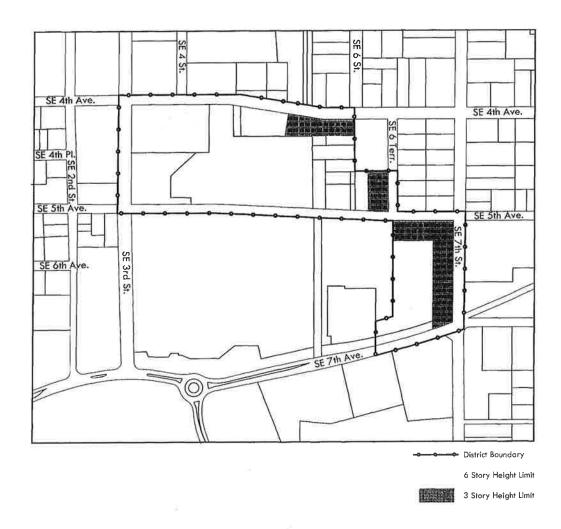


Figure 3.1 Height Limits—Power District



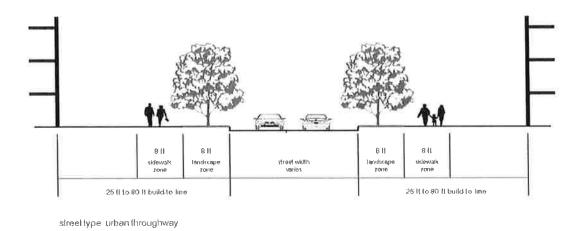


Figure 4.0 Public Realm Requirements—Urban Throughway

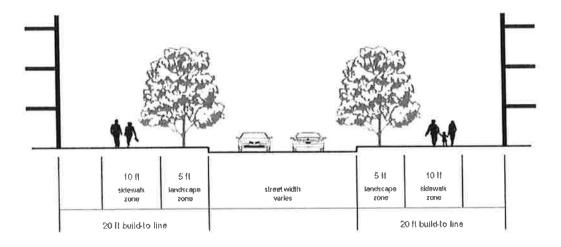


street type storefront street

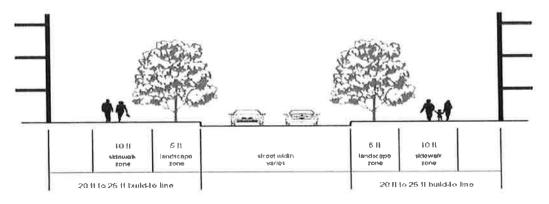Figure 4.1 Public Realm Requirements—Storefront Street




street type principal street

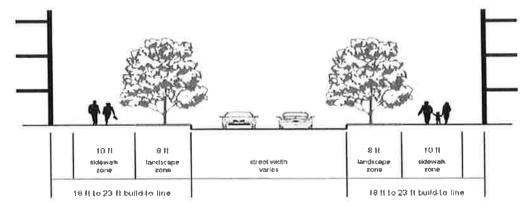Figure 4.2 Public Realm Requirements—Principal Street




street type: local street

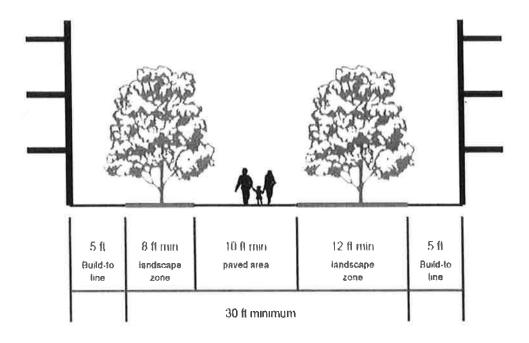Figure 4.3 Public Realm Requirements—Local Street



urban walkway type: standard

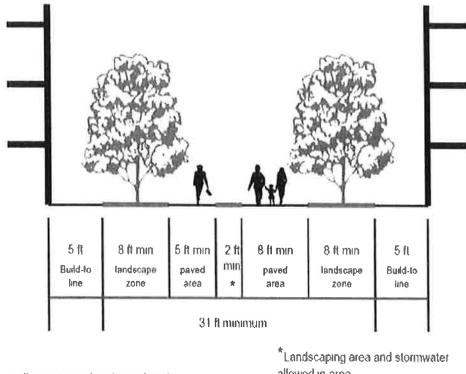Figure 4.4 Public Realm Requirements—Standard Urban Walkway



urban walkway type: boulevard style allowed in area

Figure 4.5 Public Realm Requirements—Boulevard Style Urban Walkway

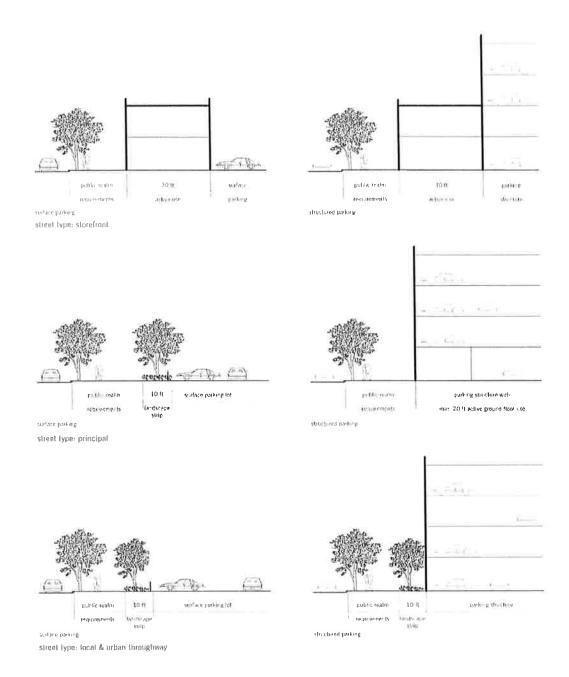


Figure 5.0 Parking Scenarios

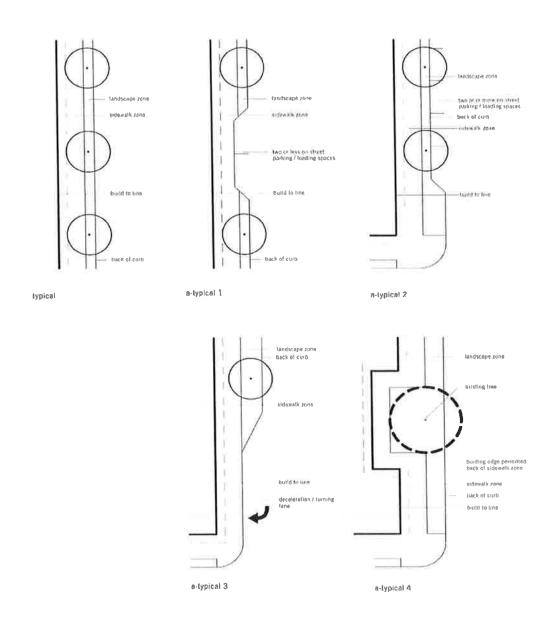


Figure 6.0 Streetscape Scenarios

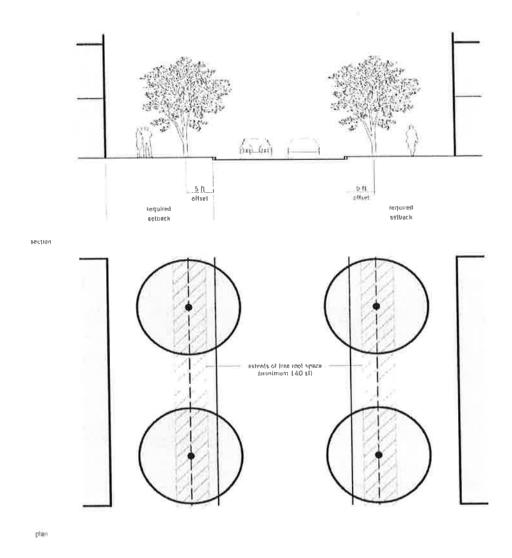


Figure 6.1 Streetscape with 4' Clear Zone

NOTE: Clear zone will vary according to the design speed of the road and the presence or lack of curbing.


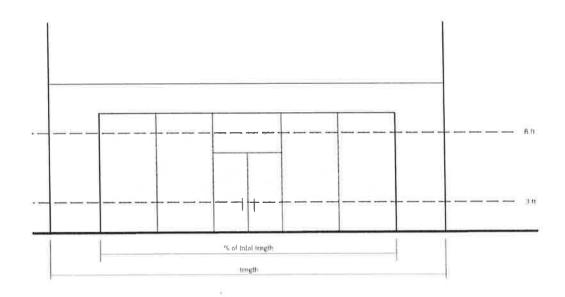


Figure 7.0 Glazing

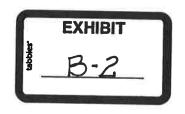(Ord. No. 041058, § 2, 11-28-05; Ord. No. 100721, § 2, 7-7-11; Ord. No. 110642, § 2, 6-7-12; Ord. No. 120179, §§ 1, 2, 3-7-13; Ord. No. 120789, § 2, 5-16-13; Ord. No. 120807, § 3, 5-16-13; Ord. No. 120426, § 1, 6-20-13; Ord. No. 121118, §§ 1—3, 3-6-14; Ord. No. 130689, § 1, 6-19-14; Ord. No. 140130, § 8, 9-4-14; Ord. No. 140030, §§ 2—6, 12-18-14; Ord. No. 140190, § 12, 4-16-15)



Sec. 30-233. - Criteria for issuance.

No special use permit shall be approved by the city plan board unless the following findings are made concerning the proposed special use:

- (1) That the use or development complies with all required regulations and standards of this chapter and all other applicable regulations.
- (2) That the proposed use or development will have general compatibility and harmony with the uses and structures on adjacent and nearby properties.
- (3) That necessary public utilities are available to the proposed site and have adequate capacity to service the proposed use and development.
- (4) That the use or development is serviced by streets of adequate capacity to accommodate the traffic impacts of the proposed use.
- (5) That screening and buffers are proposed of such type, dimension and character to improve compatibility and harmony of the proposed use and structure with the uses and structures of adjacent and nearby properties.
- (6) That the use or development conforms with the general plans of the city as embodied in the city comprehensive plan.
- (7) That the proposed use or development meets the level of service standards adopted in the comprehensive plan and conforms with the concurrency management requirements of this chapter as specified in article III, division 2.

(Ord. No. 3777, § 1, 6-10-92)

Appendix C

Supplemental Documents



February 2, 2016

City of Gainesville Planning Department Thomas Center B 306 NE 6th Avenue Gainesville, FL 32601

Ref: Inception at Innovation Square Performance Standards Letter



Dear Staff:

Pursuant to Section 30-345 of the City's LDC we are providing this letter as satisfaction of the General Performance Standards as set forth in the section.

The Inception at Innovation Square project meets the standards as follows:

- (1) Fire and explosion hazards: Limited storage of flammable or explosive materials is proposed at the site.
- (2) Radiation: No radiation operations are proposed for this development.
- (3) Electromagnetic radiation: No electromagnetic radiation is proposed for the site.
- (4) Smoke and other particulate matter. No smoke or particulate matter will be discharged from this development without proper treatment and permitting with ACEPD.
- (5) Toxic or noxious matter: No activity involving toxic or noxious matter is proposed for this development.
- (6) Waste disposal: This site will not discharge waste (liquid or solid) that will result in a violation of local, state or federal regulations.
- (7) Vibration: This use will not create any vibrations as defined in the section.
- (8) Heat, cold, dampness, or movement of air: The proposed use of the site will not affect temperature, motion or humidity of the atmosphere.
- (9) Glare: The site plan meets the City's lighting ordinance and therefore meets the performance standard for glare.
- (10) Noise, Odor, etc.: Use of the site will not create noise, odor or any other irritant that will unreasonably disturb the adjoining lands.

In addition, all proposed utilities are to be underground except for those apertures (i.e.: transformers, fire hydrants, etc.) that are defined by code to be allowed to be above grade.

Sincerely,

CHW

Holly Simon, E.I. Project Manager

L:\2015\15-0035\Engineering\City County\160202 Submittal 1\LTR 160202 Inception at Innovation Square Performance Standards Letter, docs

PB-16-25 SUP Inception at Innovation Square 805-819 W University Ave

WWW.CHW-INC.COM





TEL: (352) 331-1976 TEL: (352) 414-4621 132 NW 76th Driv 101 NE 1st



planning surveying engineering construction.

MEMORANDUM

To:

Bedez Massey, City Planner

15-0035

From:

Craig Brashier, AICP, Sr. Project Manager

Date:

March 28, 2016

RE:

Inception - Sidewalk Zone and Landscape Zone Modification Requests

The proposed Inception site on W. University Avenue is located within the UMU-2 Zoning District. Consistent with Land Development Code Sec. 30-65.2(b)(2)a., the applicant is requesting board modifications from the sidewalk zone and landscape zone requirements.

LDC Sec. 30-65.2(e)(4) and the Streetscape Dimensions Table require a minimum 10 ft. sidewalk zone along Storefront Streets and Local Streets. W. University Avenue is classified as a Storefront Street. SW 8th Street and SW 1st Avenue are classified as a Local Streets.

The applicant is requesting a reduction in the required minimum sidewalk zone width *from 10 ft. to 7.5 ft. along W. University Road*. Pavers are provided in front of the building's entrances on W. University Avenue for a 57-ft wide section. Within this 57 ft. wide section a sidewalk zone greater than 10 ft. is created. LDC Sec. 30-65.2(e)(4)e. requires that the owner / developer construct new sidewalks to align with existing sidewalks on abutting properties. The sidewalk zone reduction along W. University Avenue is requested to align with the abutting sidewalk to the west. The reduction will also allow for landscaping between the sidewalk zone and the building as shown on the Landscape Plan.

The applicant is requesting a reduction in the required minimum sidewalk zone width *from 10 ft. to 5 ft. along SW 8th Street and SW 1st Avenue.* LDC Sec. 30-65.2(e)(4)e. requires that the owner / developer construct new sidewalks to align with existing sidewalks on abutting properties. The sidewalk zone reduction along SW 1st Avenue is necessary to align with the existing sidewalk to the west. The reduction will also allow for the landscape zone to exceed the 8 ft. minimum requirement along SW 1st Avenue. The reduction along SW 8th Street is requested to maintain consistency and uniformity around the building and to provide additional landscaping between the sidewalk and building as shown on the Landscape Plan.

LDC Sec. 30-65.2(e)(5) Landscape Zone and the Streetscape Dimensions Table require a minimum 5 ft. landscape zone along Storefront Streets and 8 ft. along Local Streets. As previously stated, W. University Avenue is classified as a Storefront Street and SW 8th Street and SW 1st Avenue are classified as a Local Streets.

The applicant is requesting a reduction in the required minimum landscape zone width *from 5 ft. to 0 ft. along W. University Road*. Pavers are provided in front of the building's entrances on W. University Avenue for a 57-ft wide section. Within this 57 ft. wide section no landscape zone is provided. Where a landscape zone is provided, the 5 ft. minimum is exceeded. However, the landscape zone is not provided adjacent to the curb. The provided landscape zone is between the building and the sidewalk zone which allows the applicant to align the new sidewalk with existing sidewalk to the west.

The applicant is requesting a reduction in the required minimum landscape zone width *from 8 ft. to 5 ft. along SW 8th Street*. An additional landscape area is provided between the sidewalk and the building which provides for a total landscape width that exceeds the minimum 8 ft. width. However, a 5 ft. landscape zone is provided adjacent to the curb as required in LDC Sec. 30-65.2(e)(5)a.

In conjunction with the sidewalk zone modification along SW 8th Street and SW 1st Avenue and the landscape zone modification along SW 8th Street, the applicant is also requesting a modification from the structured parking cross section along a local street shown in Figure 5.0. In addition to the public realm requirements for the mixed-use building, Figure 5.0 requires an additional 10 ft. wide landscape area adjacent to the parking garage. The applicant is requesting to reduce the minimum required landscape area between the parking garage and the sidewalk *from 10 ft. to 5 ft. along SW 8th Street* and *from 10 ft. to 2 ft. along SW 1st Avenue*. Similar to the justifications for the sidewalk zone and landscape zone modifications, this modification to the cross section shown in Figure 5.0 is necessary to maintain consistency with existing sidewalk alignments and meet the UMU-2 build-to line requirements.

LDC Sec. 30-65.2(d)(2)c. requires that non-residential and multi-family buildings fronting a street shall have a functional entrance at least every 150 ft. The applicant is requesting a modification from this requirement along SW 8th Street. The majority of the ground floor along SW 8th Street is a parking garage. The functional entrance for pedestrians along SW 8th Street will be via the driveway into the parking garage. From this entrance they can then access the residential units above and the non-residential uses fronting W. University Avenue, as well as the parking garage itself. From the driveway entrance south to the end of the building is ±170 ft. Therefore the applicant is requesting this modification. A secondary entrance to the garage is not required along this façade. The building meets Florida Building Code requirements and is consistent with the intent of the UMU-2 requirements by providing two (2) additional entrances along the western side of the building which does front a sidewalk.

We trust the requested modification and justification listed above, along with the development plans are acceptable for presentation to the board. If you have any questions, please contact CHW at 352-331-1976.

L:\2015\15-0035\Engineering\City County\Working Files\MEMO_160328_UMU-2 Modifications.docx



Appendix D

Application and Neighborhood Workshop Documents



DEVELOPMENT PLAN REVIEW APPLICATION DI ANNING & DEVELOPMENT SERVICES

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Applicant(s)/Agent((s), if different	
Name: CHW		
Address: 132 NW 76th Drive		
Gainesville, FL 326	307	
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ditional agents, attach	intormation)	
	Applicant(s)/Agent(

Certified Cashier's Receipt:



PROPERTY OWNER AFFIDAVIT

FEB-22016

Owner Name: TBG Innovation Square, LL	С	1/2	
Address:5605 Glenridge Drive, Suite 100	Phone: (678)	514-5901	
Atlanta, GA 30342			
Agent Name: CHW			
Address: 132 NW 76th Drive	Phone: (352)	331-1976	
Gainesville, FL 32607			
Parcel No.: 13200-000-000, 13201-000-00	0, 13209-000-0	00	
Acreage: ±0.94	S : 5	T : 10	R : 20
Requested Action: Authorization to apply City of Gainesville, Gainesville Regional Management District.			
I hereby certify that: I am the property owner of record. I am the property o	before me this Benit, In	3 151 day o	of who is/are
GEORGIA JULY 15, 2019 UBLAC ALB COUNTY			

DESCRIPTION: (PER FURNISHED TITLE COMMITMENT)

PARCEL 1:
THE WEST 35 FEET OF LOT 2, THE EAST 45 FEET OF LOT 3, ALL
OF LOT 14, AND THE WEST 35 FEET OF LOT 15, INCLUDING THE
AREA OF THE ALLEY LYING BETWEEN SAID LOTS TO THE MID
POINT OF SAID ALLEY, ALL LYING IN BLOCK 1, OF UNIVERSITY
PLACE, AS PER PLAT THEREOF RECURDED IN PLAT BOOK A, PAGE
77 OF THE PUBLIC RECORDS OF ALACHUA COUNTY, FLORIDA.

PARCEL 2:
LOT 1 AND THE EAST 20 FFFT OF LOT 2 AND THE NORTH 24
FEET OF THE EAST 20 FEET OF LOT 15 AND THE NORTH 24 FEET
OF LOT 16, BLOCK 1, OF UNIVERSITY PLACE, AS PER PLAT
THEREOF RECORDED IN PLAT BOOK A, PAGE 77 OF THE PUBLIC
RECORDS OF ALACHUA COUNTY, FLORIDA, TOGETHER WITH THE
ALLET LYING ADJACENT THERETO.

PARCEL 3: LOT 15 AND ALL OF LOT 16, BLOCK 1, OF UNIVERSITY PLACE, AS PER PLAT THEREOF RECORDED INPLAT BOOK A. PAGE 77 OF THE PUBLIC RECORDS OF ALACHUA COUNTY, FLORIDA, LESS AND EXCEPT THE NORTH 24 FEET OF SAID LOT 16 AND LESS AND EXCEPT THE NORTH 24 FEET OF THE EAST 20 FEET OF SAID LOT 15 AND LESS AND EXCEPT THE WEST 35 FEET OF SAID LOT 15.

ARTICLES OF ORGANIZATION

OF

TBG INNOVATION SQUARE, LLC

The undersigned Member or Authorized Representative of a Member signs these Articles of Organization and forms a limited liability company (the "Company") under the Florida Revised Limited Liability Company Act (the "Act"), as follows:

NAME

FFB - 2 2016

The name of the Company is: TBG INNOVATION SQUARE, LLC

MAILING ADDRESS AND STREET ADDRESS

The mailing address and street address of the principal office of the Company is: c/o The Benoit Group, Premier Plaza One, 5605 Glenridge Drive, Suite 100, Atlanta, GA 30342.

NAME AND ADDRESS OF MANAGER

The name and address of the sole Manager of the Company is Eddy Benoit, Jr., c/o The Benoit Group, Premier Plaza One, 5605 Glenridge Drive, Suite 100, Atlanta, GA 30342.

EXISTENCE

The Company's existence will commence upon filing.

INITIAL REGISTERED OFFICE AND AGENT

The name and street address of the initial registered agent and office of the Company are: NRAI Services, Inc., 1200 South Pine Island Road, Plantation, FL 33324.

Eddy Benoit, Jr. Member

ACCEPTANCE BY REGISTERED AGENT

I accept the appointment as Registered Agent of the Company to accept service of process on its behalf at the place designated in these Articles of Organization. I am familiar with, and accept, the obligations of my position as registered agent as provided for in the Act.

NRAI Services, Inc. 1200 South Pine Island Road Plantation, FL 33324

Dated: January __, 2016



APPLICATION FOR SPECIAL USE PERMIT Planning & Development Services

Petition No. PB-16-25 SUP For 1st Step Mtg Date: EXT Tax Map No. R Account No. 001-660-6680-3401 [] Account No. 001-660-6680-1124 (Enter Account No. 001-660-6680-1125 (Enter Application for a special use permit will be accepted (First Step Meeting). Application to be completed by preliminary development plan. Incomplete application	ree: \$ 1086.00 Z Fee: \$ 543.06 prise Zone) [A prise Zone Credit [A pri
Name of Owner(s) (please print)	Applicant(s)/Agent(s), if different
Name: TBG Innovation Square, LLC	Name: CHW
Address: 5605 Glenridge Drive, Suite 100	Address: 132 NW 76th Drive
Atlanta, GA 30342	Gainesville, FL 32607
CONTACT AGENT	
Phone: Fax:	Phone: (352) 331-1976 Fax: (352) 331-2476
Owner's Signature:	P
(If additional owners, please include on back)	
PROPERTY INFORMATION: (Information be Permit is being requested.) Street address: 805-819 West University Avenue, G Tax parcel no(s): 13200-000-000, 13201-000-000, 13 Legal description (use separate sheet, if needed): 5	sainesville, FL 32601 3209-000-000
I hereby attest to the fact that the above supplied (are) the true and proper identification of the area Signature of applicant:	parcel number(s) and legal description(s) is a for which the permit is being requested. Date:

Certified Cashier's Receipt:

A Specia	ıl Use Permit of the Land I	is requested p Development	oursuant to Sec Code, City of (tion 30-65.2, Subsection (d), Paragraph Gainesville, to allow the following use:		
A maximum residential density up to 125 du/ac. Proposed density is 117 du/ac.						
A maxin	num residentia	il defisity up to	125 durac. PTO	bosed density to 117 days.		
A prelim	inary site pla	n(is) is not req	uired and(is) is	not attached.		
Existing	zoning classi	ification:	MU-2]	Existing land use designation:UMU-2		
Existing use of property: _Commercial/Retail and Single Family Residential						
SURRO	LINDING PI	ROPERTY I	NFORMATIO	N: (List all uses surrounding the subject		
property	under "Exist	ing use." Sta	ff is available t	to supply zoning and land use information.)		
property	Zoning	Land Use	11 15 0, (0.10)	Existing Use		
Mouth			0			
North	UMU-2	UMU-2	Commercial			
South	UMU-2	UMU-2	Vacant			
East	UMU-2	UMU-2	UF/Institution	al		
West	West UMU-2 UF/Office					
 TO THE APPLICANT: (Please sign the bottom of this application after you have read the following.) The City of Gainesville will notify owners of property within 400 feet of the subject property of this application. No application for a Special Use Permit shall be entertained within 2 years after the denial or withdrawal of a request for the same use for the same property. The City Plan Board's decision concerning a Special Use Permit may be appealed by the applicant to a hearing officer within 15 days of the date notification of the decision is sent by certified mail to the applicant. Signature: 						
		er (please pri		Name of Owner (please print)		
		on Square, LLC		Name: Address:		
		e Drive, Suite	100	Address.		
	Atlanta, GA 30					
Dhana	CONTAC	TAGENT		Phone: Fax:		
Phone: Fax: Owner's Signature:				Owner's Signature:		
		ase list on sepai	rate sheet)	O HAZEL O DABLESON OF		

Reference: Chapter 30, Land Development Code


City Code of Ordinances, Article VII, Division 5

DESCRIPTION: (PER FURNISHED TITLE COMMITMENT)

PARCEL 1:
THE WEST 35 FEET OF LOT 2, THE EAST 45 FEET OF LOT 3, ALL
OF LOT 14, AND THE WEST 35 FEET OF LOT 15, INCLUDING THE
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PUBLIC RECORDS OF ALACHUA COUNTY, FLORIDA, LESS AND
EXCEPT THE NORTH 24 FEET OF SAID LOT 16 AND LESS AND
EXCEPT THE NORTH 24 FEET OF THE EAST 20 FEET OF SAID LOT
15 AND LESS AND EXCEPT THE WEST 35 FEET OF SAID LOT 15.



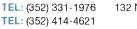132 NW 76th Drive, Gainesville, Florida 32607 101 NE 1st Avenue, Ocala, Florida 34470 WWW.CHW-INC.COM

planning.surveying.engineering.construction.



MEMORANDUM

To:

Neighbors of 805-819 West University Avenue

15-0035

From:

Holly Simon, El, Project Manager

Date:

January 13, 2016

RE:

Neighborhood Workshop Public Notice

CHW will be holding a Neighborhood Workshop to discuss a proposed development plan on ±0.94 acres located at 805-819 West University Avenue in the City of Gainesville, FL. The project is currently designed for a mixed-use multi-story development consisting of 110 dwelling units, 125 parking spaces, and ±4,000 square feet of non-residential ground-level retail, all served by an internal parking structure. The project site consists of Alachua County Tax Parcels 13200-000-000, 13201-000-000, and 13209-000-000. The site has a Future Land Use designation of Urban Mixed Use 2 and is zoned Urban Mixed-Use 2 (UMU2).

Workshop Information

Date:

Wednesday, January 27, 2016

Time:

6:00 p.m.

Place:

Alachua County Library – Headquarters Branch

Meeting Room A

401 East University Ave Gainesville, FL 32601

Contact:

Holly Simon, El

(352) 331-1976

This is not a public hearing. The purpose of the meeting is to inform neighboring property owners of the proposed site plan and to seek comments. We look forward to seeing you at the meeting.

Directions to Workshop:

Head North on SW 13th Street towards SW 1st Place. Turn right onto West University Avenue, travel 1.1 miles. The library is located on the right.

PUBLIC NOTICE

A Neighborhood Workshop will be held to discuss a proposed development plan on ±0.94 acres located at 805-819 West University Avenue in the City of Gainesville, FL. The project is currently designed for a mixed-use multi-story development consisting of 110 dwelling units, 125 parking spaces, and ±4,000 square feet of non-residential ground-level retail, all served by an internal parking structure. The project site consists of Alachua County Tax Parcels 13200-000-000, 13201-000-000, and 13209-000-000. The site has a Future Land Use designation of Urban Mixed Use 2 and is zoned Urban Mixed-Use 2 (UMU2).

This is not a public hearing. The workshop's purpose is to inform neighboring property owners of the proposal's nature and to seek their comments.

The meeting is January 27, 2016, @ 6:00 p.m. at the Alachua County Library – Headquarters Branch, Meeting Room A, 401 East University Ave, Gainesville, FL 32601.

Contact:

Holly Simon, EI **Phone Number:** (352) 331-1976





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DEMOCRATIC BACE HILLARY CLINTON

State Dept. to review 29,000 pages of aide's emails

WAS HINGTON - The WAR HDICTON - The State Department has agreed to review 10,000 pages of emails from Huma fiberin, a close side to Democratic presidents, and that will apply the to conditate filling Clinton, from their days at the State Department for possible public release under a new least agreement with a public release under a new legal a greement with a conservative legal group-hat even as Cliston presses her campaign, many of the em alis would not be publicly released until six months after the election. Under a schedule adopted Monday by



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U.S. District Judge Beryl U.S. Diatrict judge flery; Howell, inwyers for the Biate Department and the conservative group judi-cial Wakch agreed that the agency will start in Marcha Abedin series received on chails also showed that Claims' spirists computer Abedin frequently com-server between 2009 and minicided with her from

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ment to review for release 400 Abedin emails each month starting March 1, but the public production of documents will not be November presidential election. Justice Depart-ment lawyers had initially tried to extend the process

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PUBLIC NOTICE

A Neighborhood Weelshop will be held to allocute a proposed development plan 002/034 acres bound at 303-319 West University Ayense in the City-of Gatterwile, FL. BIY Went (LONGINIT) Assume in the City of Uniformitie, Fig. .
The project in currently designed for a midst-daw multi-stary development consisting of 110 cheeling union, 125 parking spaces, and 24,000 square feet of non-residential ground-lavel stead, all serves by an internal parking structure. The propert site consist of Alasbus County Tax Paradia 1130-000-000, 1330-040-000, and 3209-000-000. The mix has a Future Lawr Une dissipation of Union Miled Use 2 and is arred Urino Miles Use 2 (UMU2).

This is not a public bearing. The worldshop's purpose is to info up teighboring groupers owners of the propositional and to with their comments.

The massing is Burnary 27, 2016, §1 640 pm. at the Allechan County Library - Headquarters Branch Meeting Room A. 401 East University Aug Galmerolle, FL 32001.

Contact

Holly Simon, El Phone Number: (352) 33:1-1976

CHM

real estate **auctions** Residential Lots Auction Jan 17-19

Nominal Opening Bids: \$1,000 co op Co's *Chia Salaron Fist high damp of high days -Anti Salaron Time days -Anti Salaron Time Market Salaron Time

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Neighborhood Workshop Notice 13686-000-000 Benoit Mixed use GARY ANGLIN 102 NE 10TH AVE 2ND FLOOR GAINESVILLE, FL 32601

Neighborhood Workshop Notice 13683-000-000 Benoit Mixed use CASSIE & CERVENKA W/H 14512 SW 118TH AVE ARCHER, FL 32618

Neighborhood Workshop Notice 13694-010-005 Benoit Mixed use AARON COMPEAN 12300 SW 2ND ST PLANTATION, FL 33325

Neighborhood Workshop Notice 13687-000-000 Benoit Mixed use DUDDING & EVERETT H/W 111 LIDGE BRANCH JACKSONVILLE, FL 32259

Neighborhood Workshop Notice 13204-000-000 Benoit Mixed use FRIEDMAN & FRIEDMAN CO-TRUSTEES 16127 DAYSAILOR TRAIL LAKEWOOD RCH, FL 34202-5616

Neighborhood Workshop Notice 13689-001-000 Benoit Mixed use HAZEL GEORGE LLC PO BOX 670 VASHON, WA 98070

Neighborhood Workshop Notice 12921-250-000 Benoit Mixed use INNOVATION SQUARE LLC 720 SW 2ND AVE STE 108 GAINESVILLE, FL 32601

Neighborhood Workshop Notice 13681-000-000 Benoit Mixed use BRIAN KALT 6924 SE 183RD PL MICANOPY, FL 32667

Neighborhood Workshop Notice 13204-001-000 Benoit Mixed use M&R UNITED INC 402 HIGH POINT DR STE 101 COCOA, FL 32926

Neighborhood Workshop Notice 13694-010-002 Benoit Mixed use ASHLEY PENNEWILL 1610 E WRIGHT ST PENSACOLA, FL 32501-4354 Neighborhood Workshop Notice 13720-000-000 Benoit Mixed use JARIEL R BORTNICK 124 E 24TH ST APT 1H NEW YORK, NY 10010

Neighborhood Workshop Notice 13710-000-000 Benoit Mixed use CHECKERS DRIVE-IN RESTAURANTS 4300 W CYPRESS ST STE 600 TAMPA, FL 33607-4157

Neighborhood Workshop Notice 13697-000-000 Benoit Mixed use T J DAVISON TRUSTEE 1411 NW 2ND ST GAINESVILLE, FL 32601-4231

Neighborhood Workshop Notice 13693-001-000 Benoit Mixed use DAVID DUNCAN PO BOX 492 NEW YORK, NY 10163

Neighborhood Workshop Notice 13694-010-001 Benoit Mixed use GARCIA-OTERO & PINO W/H 2401 ALHAMBRA CIR CORAL GABLES, FL 33134

Neighborhood Workshop Notice 13682-000-000 Benoit Mixed use PHILLIP H HEFLIN PO BOX 13895 GAINESVILLE, FL 32604

Neighborhood Workshop Notice
13200-000-000 **** Benoit Mixed use
INNOVATION SQUARE LLC
747 SW 2ND AVE IMB #49
GAINESVILLE, FL 32601

Neighborhood Workshop Notice 13208-000-000 Benoit Mixed use CARLOS P LAMAR III 8005 SW 105TH AVE GAINESVILLE, FL 32608

Neighborhood Workshop Notice 13725-000-000 Benoit Mixed use ROBERT A MITCHELL 201 NW 10TH AVE GAINESVILLE, FL 32601

Neighborhood Workshop Notice 13691-000-000 Benoit Mixed use PINKOSON & UPSHAW CO-TRUSTEES 2820 NW 38TH DR GAINESVILLE, FL 32605-2680 Neighborhood Workshop Notice 12892-000-000 Benoit Mixed use CAPITAL ASSETS GROUP 321 SW 13TH ST GAINESVILLE, FL 32601

Neighborhood Workshop Notice 13694-010-004 Benoit Mixed use KEITH CHISHOLM 19522 SHADY HAMMOCK LN ODESSA, FL 33556

Neighborhood Workshop Notice 13694-010-006 Benoit Mixed use DE FORD PROPERTIES LLC 19522 SHADY HAMMOCK LN ODESSA, FL 33556

Neighborhood Workshop Notice 13206-000-000 Benoit Mixed use GEORGE FORRON 21 SW 10TH ST GAINESVILLE, FL 32601-6204

Neighborhood Workshop Notice
13661-000-000 Benoit Mixed use
GRESHAM MANAGEMENT GROUP INC
4500 SW 80TH PL
GAINESVILLE, FL 32608

Neighborhood Workshop Notice 13662-000-000 Benoit Mixed use INGRAM & STILP H/W 3315 NW 46TH AVE GAINESVILLE, FL 32605

Neighborhood Workshop Notice 13719-000-000 Benoit Mixed use JACK USA INC 5542 NW 43RD ST GAINESVILLE, FL 32653

Neighborhood Workshop Notice 13722-000-000 Benoit Mixed use LE & TRAN H/W 5313 NW 45TH LN GAINESVILLE, FL 32606

Neighborhood Workshop Notice 13680-000-000 Benoit Mixed use JOE M MORGAN 1567 LAKEWAY DR FLEMING ISLAND, FL 32003

Neighborhood Workshop Notice 13684-001-000 Benoit Mixed use KEVIN R POWERS 711 NW 23RD AVE UNIT 4 GAINESVILLE, FL 32609 Neighborhood Workshop Notice

5th Avenue ROBERTA PARKS 616 NW 8 ST GAINESVILLE, FL 32602

Neighborhood Workshop Notice

Azalea Trails MARIE SMALL 1265 SE 12 AVE GAINESVILLE, FL 32601

Neighborhood Workshop Notice

Carol Estates South BECKY RUNNESTRAND 1816 NE 16 TER GAINESVILLE, FL 32609

Neighborhood Workshop Notice

Debra Heights SARAH POLL PO BOX 14198 GAINESVILLE, FL 32604

Neighborhood Workshop Notice

Edgewood Hills BONNIE O'BRIAN 2329 NW 30 AVE GAINESVILLE, FL 32605

Neighborhood Workshop Notice

Gateway Park HAROLD SAIVE 1716 NW 10 TER GAINESVILLE, FL 32609

Neighborhood Workshop Notice

Grove Street MARIA HUFF-EDWARDS 1102 NW 4 ST GAINESVILLE, FL 32601

Neighborhood Workshop Notice

Hidden Lake GEORGE KASNIC 2116 NW 74 PL GAINESVILLE, FL 32653

Neighborhood Workshop Notice

Kensington Park MAXINE HINGE 5040 NW 50 TER GAINESVILLE, FL 32606

Neighborhood Workshop Notice

Lamplighter LARRY NICHOLSON (PROP MGR) 5200 NE 50 DR GAINESVILLE, FL 32609 Neighborhood Workshop Notice

CITY OF GAINESVILLE ATTN: MIKE HOGE PO BOX 490 MS 11 GAINESVILLE, FL 32627

Neighborhood Workshop Notice

Black Acres/Black Pines JIM CONNOR 400 NW 32 ST GAINESVILLE, FL 32607

Neighborhood Workshop Notice

Cedar Grove II HELEN HARRIS 1237 NE 21 ST GAINESVILLE, FL 32641

Neighborhood Workshop Notice

Northwood at Possum Creek WES WHEELER 4728 NW 37 WAY GAINESVILLE, FL 32601

Neighborhood Workshop Notice

Elizabeth PL/Northwest 23rd ST GALE FORD 715 NW 23 ST GAINESVILLE, FL 32605

Neighborhood Workshop Notice

Golfview CHRIS MONAHAN 222 SW 27 ST GAINESVILLE, FL 32607

Neighborhood Workshop Notice

Hazel Heights ALLAN MOYNIHAN PO BOX 357412 GAINESVILLE, FL 32635

Neighborhood Workshop Notice

Highland Court Manor DAVID SOUTHWORTH 3142 NE 13 ST GAINESVILLE, FL 32609

Neighborhood Workshop Notice

Kingswood Court JOHN ORTON 5350 NW 8 AVE GAINESVILLE, FL 32605

Neighborhood Workshop Notice

Landmark Woods JACK OSGARD 4332 NW 12 PL GAINESVILLE, FL 32605 Neighborhood Workshop Notice

Ashton ROXANNE WATKINS 4415 NW 58 AVE GAINESVILLE, FL 32653

Neighborhood Workshop Notice

Capri JOHN DOLES 4539 NW 37 TER GAINESVILLE, FL 32605

b

Neighborhood Workshop Notice

Creekwood HELEN SCONYERS 2056 NW 55 BLVD. GAINESVILLE, FL 32653

Neighborhood Workshop Notice

Duval GILBERT S MEANS, SR 2153 SE HAWTHORNE RD, #111 PO BOX 7 GAINESVILLE, FL 32641

Neighborhood Workshop Notice

Forest Ridge/Henderson Heights JUANITA CASAGRANDE 1911 NW 22 DRIVE GAINESVILLE, FL 32605

Neighborhood Workshop Notice

Greater Northeast Community MIRIAM CINTRON 915 NE 7 AVE GAINESVILLE, FL 32601

Neighborhood Workshop Notice

Hibiscus Park
CAROL BISHOP
2616 NW 2 AVE
GAINESVILLE, FL 32607

Neighborhood Workshop Notice

Ironwood NANCY TESTA 4207 NE 17 TER GAINESVILLE, FL 32609

Neighborhood Workshop Notice

Kirkwood JANE BURMAN-HOLTON 701 SW 23 PL GAINESVILLE, FL 32601

Neighborhood Workshop Notice

Las Pampas PETER JANOSZ 3418 NW 37 AVE GAINESVILLE, FL 32605 Neighborhood Workshop Notice Woodland Terrace

Woodland Terrace PETER PRUGH 207 NW 35 ST GAINESVILLE, FL 32605

Neighborhood Workshop Notice

Mason Manor JOANNA LEATHERS 2550 NW 13 AVE GAINESVILLE, FL 32605

Neighborhood Workshop Notice

Northwood SUSAN W. WILLIAMS PO BOX 357492 GAINESVILLE, FL 32653

Neighborhood Workshop Notice

Oakview DEBRA BRUNER 914 NW 14 AVE GAINESVILLE, FL 32601

Neighborhood Workshop Notice

Pine Park
DELORES BUFFINGTON
721 NW 20 AVE
GAINESVILLE, FL 32609

Neighborhood Workshop Notice

Porters Community GIGI SIMMONS 712 SW 5 ST GAINESVILLE, FL 32601

Neighborhood Workshop Notice

Raintree RONALD BERN 1301 NW 23 TER GAINESVILLE, FL 32605

Neighborhood Workshop Notice

Royal Gardens DOUGLAS BURTON 2720 NW 27 PL GAINESVILLE, FL 32605

Neighborhood Workshop Notice

Southeast Evergreen Trails MAUREEN RESCHLY 1208 SE 22 AVE GAINESVILLE, FL 32641

Neighborhood Workshop Notice

Stephen Foster ROBERT PEARCE 714 NW 36 AVE GAINESVILLE, FL 32609 Neighborhood Workshop Notice

Lincoln Estates DORIS EDWARDS 1040 SE 20 ST GAINESVILLE, FL 32601

Neighborhood Workshop Notice

Pineridge BERNADINE TUCKER 9 TURKEY CREEK ALACHUA, FL 32615

Neighborhood Workshop Notice

Northeast Neighbors SHARON BAUER 1011 NE 1 AVE GAINESVILLE, FL 32601

Neighborhood Workshop Notice

Mill Pond HAROLD HANEL 309 NW 48 BLVD GAINESVILLE, FL 32607

Neighborhood Workshop Notice

Kirkwood KATHY ZIMMERMAN 1127 SW 21 AVE GAINESVILLE, FL 32601

Neighborhood Workshop Notice

Rainbows East JOE THOMAS 5014 NW 24 TER GAINESVILLE, FL 32605

Neighborhood Workshop Notice

Ridgeview ROB GARREN 1805 NW 34 PL GAINESVILLE, FL 32605

Neighborhood Workshop Notice

Shadow Lawn Estates CONNIE SPITZNAGEL 3521 NW 35 PL GAINESVILLE, FL 32605

Neighborhood Workshop Notice

Springhill/Mount Olive VIVIAN FILER 1636 SE 14 AVE GAINESVILLE, FL 32641

Neighborhood Workshop Notice

Suburban Heights BETH GRAETZ 4321 NW 19 AVE GAINESVILLE, FL 32605 Neighborhood Workshop Notice

Madison Park CHARLES FLOYD 1911 N.W. 36 DR GAINESVILLE, FL 32605

Neighborhood Workshop Notice

North Lincoln Heights ANDREW LOVETTE SR. 430 SE 14 ST GAINESVILLE, FL 32601

Neighborhood Workshop Notice

Northwest Estates VERN HOWE 3710 NW 17 LN GAINESVILLE, FL 32605

Neighborhood Workshop Notice

Appletree JUDITH MORROW 3616 NW 54 LANE GAINESVILLE, FL 32653

Neighborhood Workshop Notice

Pleasant Street DOTTY FAIBISY 505 NW 3 ST GAINESVILLE, FL 32601

Neighborhood Workshop Notice

Rainbows End SYLVIA MAGGIO 4612 NW 21 DR GAINESVILLE, FL 32605

Neighborhood Workshop Notice

Ridgewood KERRI CHANCEY 1310 NW 30 ST GAINESVILLE, FL 32605

Neighborhood Workshop Notice

South Black Acres DEANNA MONAHAN 14 SW 32 ST GAINESVILLE, FL 32607

Neighborhood Workshop Notice

Springtree KATHY MEISS 2705 NW 47 PL GAINESVILLE, FL 32605

Neighborhood Workshop Notice

Sugarfoot Community/Anglewood HEATHER REILLY 426 SW 40 TERRACE GAINESVILLE, FL 32607 Neighborhood Workshop Notice Sugarhill CYNTHIA COOPER

1441 SE 2 TER GAINESVILLE, FL 32601

Neighborhood Workshop Notice

University Park JIMMY HARNSBERGER 402 NW 24 ST GAINESVILLE, FL 32604

Neighborhood Workshop Notice

Pinebreeze JUDITH MEDER 3460 NW 46 PL GAINESVILLE, FL 32605

Neighborhood Workshop Notice

Ashton
ASHTON HOMEOWNERS ASSOC
5200 NW 43 ST STE 102
GAINESVILLE, FL 32606

Neighborhood Workshop Notice

Eagle Eyes BEATRICE ELLIS 316 NE 14 ST GAINESVILLE, FL 32641

Neighborhood Workshop Notice

Porters INA HINES 320 SW 5 AVE GAINESVILLE, FL 32601

Neighborhood Workshop Notice

University Park MEL LUCAS 620 E UNIVERSITY AVE GAINESVILLE, FL 32601

Neighborhood Workshop Notice

LARRY SCHNELL 2048 NW 7 LN GAINESVILLE, FL 32603

Neighborhood Workshop Notice

BOBBIE DUNNELL 3118 NE 11 TER GAINESVILLE, FL 32609

Neighborhood Workshop Notice

STEWART WELLS 6744 NW 36 DR GAINESVILLE, FL 32653 Neighborhood Workshop Notice

Suffers Landing PETER REBMAN 3656 NW 68 LN GAINESVILLE, FL 32653

Neighborhood Workshop Notice

University Village BRUCE DELANEY 75 SW 23 Way GAINESVILLE, FL 32607

Neighborhood Workshop Notice

Stephen Foster Neighborhood Assoc, Inc SANDRA WATTS KENNEDY 514 NW 31 LANE GAINESVILLE, FL 32609

Neighborhood Workshop Notice

Duckpond STEVE NADEAU 2821 NW 23 DR GAINESVILLE, FL 32605

Neighborhood Workshop Notice

Front Porch Florida, Duval JUANITA MILES HAMILTON 2419 NE 8 AVE GAINESVILLE, FL 32641

Neighborhood Workshop Notice

School Board VICK McGRATH 3700 NE 53 AVE GAINESVILLE, FL 32609

Neighborhood Workshop Notice

Millennium Bank DANNY GILLILAND 4340 NEWBERRY RD GAINESVILLE, FL 32607

Neighborhood Workshop Notice

MAC McEACHERN 1020 SW 11 TER GAINESVILLE, FL 32601

Neighborhood Workshop Notice

JAMES WOODLAND 225 SE 14 PL GAINESVILLE, FL 32601

Neighborhood Workshop Notice

BELLINGTON'S CUSTOM SERVICE % BRAXTON LINTON 1907 SE HAWTHORNE RD GAINESVILLE, FL 32641 Neighborhood Workshop Notice

Turkey Creek Forest Owners Assn ATTN: RITA SMITH 8620 NW 13 ST, #210 CLUBHOUSE OFFICE GAINESVILLE, FL 32653

Neighborhood Workshop Notice

Forest Ridge/Henderson Heights JUANITA CASAGRANDE 1911 NW 22 DRIVE GAINESVILLE, FL 32605-3953

Neighborhood Workshop Notice

Appletree CHRIS GARCIA 5451 NW 35 DR GAINESVILLE, FL 32653

Neighborhood Workshop Notice

Duckpond MELANIE BARR 216 NE 5 ST GAINESVILLE, FL 32601

Neighborhood Workshop Notice

Porters RUBY WILLIAMS 237 SW 6 ST GAINESVILLE, FL 32601

Neighborhood Workshop Notice

University of Florida LINDA DIXON PO BOX 115050 GAINESVILLE, FL 32611

Neighborhood Workshop Notice

Florida Bank LAUDE ARNALDI 13840 W NEWBERRY RD NEWBERRY, FL 32669

Neighborhood Workshop Notice

Stephen Foster Neighborhood Assoc, Inc MARIA PARSONS 439 NW 37 AVENUE GAINESVILLE, FL 32609

Neighborhood Workshop Notice

Bivens North Association PENNY WHEAT 2530 SW 14 DR GAINESVILLE, FL 32608

Neighborhood Workshop Notice KAREN BILLINGS

2123 NW 72 PL GAINESVILLE, FL 32653

Neighborhood Workshop Notice Phoenix Subdivision APRIL JONES 3214 SW 26 TERR, Unit B GAINESVILLE, FL 32608

Neighborhood Workshop Notice LEE NELSON DIRECTOR OF REAL ESTATE - UF 204 TIGERT HALL PO BOX 113100

GAINESVILLE, FL 32611-3100

Sign-In Sheet

Mixed Use Project Neighborhood Workshop 1/27/11

1 Address	Email
806 w. Lenivorsty Are	Email w.lessardeatt.n
1 /	russing ramahotmail
	10851191419-011-1
1905 NW 7 Lane	dews wante Anoi
332 NW 7647 Dr	hollysachw-inc.com
	craigbalchwinc.co
721 (12 721/ 21	
321 SW 15th St	matter jachw for cov
1) "	
	4
*	-
	332 NW 7640 Dr 11 321 SW 13th St 11



TEL: (352) 414-4621

TEL: (352) 331-1976 132 NW 76th Drive, Gainesville, Florida 32607 101 NE 1st Avenue, Ocala, Florida 34470 WWW.CHW-INC.COM

planning.surveying.engineering.construction.

MEETING MINUTES

To:

File

Project:

Inception

From:

Holly Simon, El

RE:

Neighborhood Workshop

A workshop presentation was provided for this project on Wednesday, January 28, 2016 at 6:00 PM as shown in the advertisement. The presentation included an explanation of the review process and an explanation of the proposed mixed-use development. A total of six (6) citizens and three (3) CHW employees attended the workshop. Please refer to the sign-in sheet for attendant names and addresses.

The following are comments made by the citizens who attended the workshop. Comments are not verbatim and may not be inclusive of everything discussed in the workshop. The primary discussion was based on general curiosity of the project and the overall feeling is support of this project to provide a safer, more aesthetically pleasing asset to this area.

- 1. Citizen wanted to know when the buildings would be demolished and is eager for this to occur.
- 2. Citizen was pleased that this corner would be "cleaned up".
- 3. Citizen wanted to know what the sidewalk width would be along University Avenue and whether it would adequately accommodate bicyclists and pedestrians.
- 4. Citizen wanted to know if this was student housing and what the atmosphere would be like if SO.

Appendix E

Technical Review Committee Conditions and Recommendations

Current Planning (Approvable with conditions):

- Provide correct cardinal direction for University Avenue in Item 2, Sheet C0.00. Add build-to-line requirement for SW 8th St.
- 2. The proposed development shall be subject to the permitted uses of the UMU-2 zoning and land use designations.
- The project description shall include the intended use of the proposed building, including structured parking, along with the proposed density and request for a Special Use Permit. Required and proposed density calculations shall also be provided.
- 4. Item 3, Sheet C0.00 must show calculations indicating compliance with the minimum scooter parking requirement (i.e., 1 per 4 residential units).
- Additional architectural detailing is required at the first floor level on the west end of the south elevation and the west elevation to meet UMU-2 requirements for structured parking.
- 6. Please provide dimension on Sheet A1.1.0 that shows compliance with 30 ft. active use requirement at the first floor level, per Figure 5.0, Sec. 30-65.2 of the City Land Development Code (LDC). Some sections of the first floor that face W. University Avenue appear to be less than 30 ft. in depth.
- Please provide a sample board of proposed materials and colors with the next submittal and before public hearing.
- 8. At least 10% of the provided number of bike spaces (i.e., 8 spaces) is required between the building and street.
- 9. Please be reminded that rooftop condenser units and/or other mechanical equipment must be screened from street view. Please show height of rooftop mechanical equipment relative to proposed screening on building elevations. On the new Site Line Sheet, please change the cardinal direction provided for University Avenue to West University Avenue on Sheet A3.04 (Plan 7). Please make the architectural features of the proposed building in the plan views on Sheet A3.04 consistent with those on Sheets A3.01 and A3.02. Please amend the site sections on Sheet A3.0, so that the built environment that surrounds the proposed development is consistent with existing conditions.
- 10. The proposed development is subject to the UMU-2 building articulation and design standard, not Innovation Square Development Regulations. Please correct. Please remove

reference to Innovation Square from the title block on the architectural sheets, including the photometric plan.

- 11. Deviations from the UMU-2 design standards shall require board-approved modifications as allowed in Sec. 30-65.2 of the LDC. Requests for board-approved modifications, or waivers from other applicable sections of the LDC, must be submitted in a formal letter on the next scheduled cut-off date prior to public hearing. The letter must state how the proposed development meets the stated criteria for board modifications. The development plan does not comply with all of the UMU-2 standards for structured parking in Figure 5.0. The applicant must comply or obtain a board-approved modification.
- 12. The proposed development must comply with the UMU-2 public realm requirements (i.e., build-to-line; landscape zone; sidewalk zone) along abutting right-of-ways, or obtain a board-approved modification. The development plan does not comply with all of the UMU-2 streetscape dimensions (e.g., landscape zone, sidewalk zone, street tree spacing and build-to-line), including those shown in Figure 4.1 and 4.2. Therefore, either the applicant must comply or a board-approved modification must be obtained in order to receive staff's signature on final plans and a final development order. The applicant must comply or obtain a board-approved modification.
- 13. The minimum 9 ft. clearance required for overhanging projections above the sidewalk shall be illustrated on building elevations, where applicable.
- 14. The fenestration calculations for the south elevation shall be corrected to address glazing requirements for local streets. Please note where glazed entrances are counted. Also, please show square footage of glazing required vs. what is proposed based upon the total wall area between 3 and 8 feet above grade. Please correct the glazing calculations on Sheets A3.01 and A3.02 to show compliance with the UMU-2 requirements by accurately illustrating the size of openings where glazing will be provided. A functional entrance w/sidewalk connection is required every 150 feet along sides of the proposed building fronting a street. The applicant must comply or obtain a board-approved modification.
- 15. Additional wall articulation is requested on the west side of the proposed building, where it is visible from W. University Avenue and SW 1st Avenue.
- 16. The distance between the outermost projection on each side of the proposed building and the adjacent property line shall be shown. The distance between the attached walls (e.g., southeast corner) and the adjacent property lines shall also be shown. Please label the line representing the "property line" on Sheets A3.01 and A3.02, so that it can also be shown that the distance overhanging and protruding projections extend into the sidewalk zone and/public right-of-way is consistent with UMU-2 requirements. Additional tie-downs are needed on the Horizontal Control Plan in the absence of

dimensions for all indentions and projections shown along the boundaries of the proposed building. A typical dimension for the <u>closest point on all sides</u> of the proposed building will suffice in cases where there are multiple projections of the same type and with the same distance from the property boundary.

- 17. Please illustrate required bike parking signage on the sheet of the development plan that contains details of proposed bike racks. Please also show signage details for proposed scooter parking. Some motorcycle parking with signage is recommended. Motorcycle parking with signage is recommended.
- 18. The development plan shall show the number of spaces proposed in each row of automobile parking spaces and bollard locations.
- 19. Please show on building elevations the location of exterior meter banks and bollard locations, where proposed.
- 20. A construction staging plan is required that shows where equipment, materials and ingress/egress will be located throughout the implementation of the proposed development. The applicant shall coordinate with all applicable regulatory agencies. Prior to receiving final development plan approval, the City Planning Division must receive written verification that the applicant will be able to utilize the adjoining property to the west as a construction staging area. The written verification shall include the time period, during which the adjoining property will be in use for this purpose.
- 21. The footcandle values on Sheet E0.01 are not legible. A larger scale is required.
- 22. A photometric narrative addressing the requirements in Sec. 30-344 of the LDC for the building exterior and parking garage shall be provided. Cut-sheets of proposed light fixtures are also required. Waivers from the City's lighting standards must be expressed in a letter to be included with the next development plan submittal on a designated cut-off date prior to public hearing.
- 23. The photometric plan shall include calculations showing compliance with the lighting requirements for building exteriors and parking garages in Sec. 30-344 of the LDC. This condition was not addressed in the March 15th submittal.
- 24. Prior to receiving a final development order, the applicant must provide the City Planning Division with copies of all fully executed and recorded easement document(s), if any. This condition was not addressed in the March 15th submittal.
- 25. All sheets of the development plan shall be signed and/or sealed, where required, prior to staff signing an approved development plan.

26. Future tenants/occupants of the proposed development shall be subject to all applicable code requirements in place at the time that an application for a development order and/or zoning compliance permit is filed. Please show the adjacent zoning and land use designations.

Concurrency (Approvable with conditions):

- 1. Due to the location of the property within the University of Florida Context Area, this development must comply with the provisions of Transportation Mobility Element Policy 10.1.14, concerning new multi-family residential development funding capital transit costs associated with transit service needs. Payments shall be based on a proportionate share contribution toward the additional transit service enhancements needed to serve the proposed development in the RTS a.m. and p.m. peak hours to maintain existing service levels (frequencies). The payment will be based on the expected mode split of all development trips that will use transit.
- 2. In note #19 under the PM Peak Hour column, the net total after the 40% reduction should be 35, as calculated in the revised trip generation memorandum. The number 16 is from the AM Peak Hour calculations.

Public Works (Approvable with conditions):

Roadway and Site Design:

1. The proposed scooter parking on the west side of NW 8th St. should be striped as one single bay as opposed to the three individual spaces shown.

Stormwater Management:

- 1 Payment for the SW 5th Avenue credits must be received prior to final approval by Public Works. The check can be delivered to Public Works to my attention.
- 2 It appears that the maintenance activity will occur outside of the building on the western side? How will the maintenance vehicles and personnel reach this location? It does not appear to be adequate room between the building and the property line for this access.
- 3 How will the vault be accessed in the event extensive maintenance is required?

Transit:

The response to comments indicates a concern that a bulb-out will result in lost parking spaces. Per the design provided to Holly Simon's on 3/23 via email it seems like a bulb-out could be provided that would have no impact on parking. Its addition would greatly improve accessibility

Building Inspections (No Comments)

Fire Services (Approvable as submitted)

Urban Forestry Inspector (Approvable with conditions):

- 1. Please change the wording for the tree mitigation payment. The mitigation fee is due at the time a development order is issued or a site work permit is issued for the development.
- 2. One will need to request a waiver for not meeting the code requirements for street trees along the roadways. Palm trees are not shade trees and not approved on the Gainesville's tree list as a shade tree.

Gainesville Regional Utilities (Approvable for preliminary only):

Water/Wastewater: Not Approved

Real Estate: Approved

Electric: Not Approved

Gas: Not Approved

GRUCom: No Comments

Alachua County Environmental Protection Department (Approvable with conditions):

Provide information if any emergency generators are to be installed.

Gainesville Police Department (No Comments)

Appendix F

Development Plan

DEVELOPMENT PLANS FOR

INCEPTION

GAINESVILLE, FLORIDA

SECTION 5, TOWNSHIP 10 SOUTH, RANGE 20 EAST

SUBMITTED TO

CITY OF GAINESVILLE **GAINESVILLE REGIONAL UTILITIES** ST. JOHNS RIVER WATER MANAGEMENT DISTRICT

DEVELOPER

(678) 514-5900

CIVIL ENGINEER

WALTER JARVIS, P.E. CAUSSEAUX, HEWETT, & WALPOLE, INC. 132 N.W. 76th DRIVE GAINESVILLE, FLORIDA 32607 (352) 331-1976

ARCHITECT

I. DEVELOPMENT DATA

EXISTING DATA: TOTAL AREA=

BUILD TO LINE

BUFFERS: N/A

9. FIRE PROTECTION:

3. PARKING:

PROPOSED DATA: TOTAL AREA= TOTAL IMPERVIOUS AREA= OPEN AREA=

2 SITE ZONING. URBAN MIXED USE 2 (UMU 2)

5. STORMWATER MANAGEMENT UTILITY DATA:

UESLAMPIUM: EXISTING PAYEMENT AND UTILITY REMOVAL, BUILDING CONSTRUCTION, STORMWATER SYSTEM, LANDSCAPE, AND ASSOCIATED UTILITIES. THE PROPOSED BUILDING WILL INCLUDE RETAIL AND RESIDENTIAL SPACE AND WILL INCLUDE A PARKING GARAGE. 94 DWELLING UNITS ARE ALLOWED BY CODE AND 110 DWELLING UNITS ARE REQUESTA BY A SPECIAL USE PERMIT.

4. UTILITIES.
ALL UTILITY SERVICES SHALL BE INSTALED BELOW GRADE PER LDC SECTION 30 345.
ALL UTILITY SERVICES SHALL BE INSTALED BELOW GRADE PER LDC SECTION 30 345.
ALL UTILITY SERVICES SHALL BE INSTALED BELOW GRADE PER LDC SECTION OF BE CONNECTED TO EXISTING WATER LINE ON SW 81H STREET.

WASTEWATER: - CONNECT VIA EXISTING SANITARY LINE SW 8TH STREET.

A STORMWATER SYSTEM WILL BE CONSTRUCTED ON THE SITE. TOTAL IMPERVIOUS AREA = 34,742 S.F.

11. THERE ARE NO KNOWN SPECIAL FIRE PROTECTION CONCERNS. N/A

ELECTRIC. - NEW ELECTRIC TO BE CONNECTED TO EQUIPMENT SOUTH OF SW 1ST AVENUE

THE PROJECT MUST COMPLY WITH ALL NPDES CRITERIA BOTH DURING AND AFTER CONSTRUCTION REFUSE COLLECTION: INTERIOR TRASH COLLECTION, REFER TO ARCHITECTURAL PLANS FOR DETAILS.

THE BUILDING SHALL COMPLY WITH THE FLORIDA FIRE PREVENTION CODE. FIRE PROTECTION SYSTEMS PROVIDED IN THE STRUCTURES SHALL BE INSTALLED IN FULL COMPLIANCE WITH THE APPROPRIATE FIRE PROTECTION AND BUILDING CONSTRUCTION STAMDARDS. ALL STABILIZED SURFACES MUST BE IN PLACE PRIOR TO ANY ACCUMULATION OF COMBUSTBLES ON SITE.

THE BUILDING IS SPRINKLED, IN BUILDING PUBLIC SAFETY RADIO ENHANCEMENT SYSTEMS SHALL BE PROVIDED IN ALL NEW BUILDINGS SWIFEE BUILDINGS WHERE MINIMUM RADIO SIGNAL STRENGTH FOR FIRE DEPARTMENT COMMUNICATIONS IS NOT ACHIEVED AT A

THE OWNER OR THE OWNER'S AUTHORIZED AGENT SHALL DEVELOP A FIRE SAFETY PROGRAM TO ADDRESS ALL ESSENTIAL FIRE AND LIFE SAFETY REQUIREMENTS FOR THE DURATION OF DEMOLITION, AS TERRATION AND CONSTRUCTION, AS SPECIFIED IN THE FIGURA THE PREVENTION CODE, INCLUDING NFTA 2-11, THE FIRE SAFETY PROGRAMS HALL INCLUDE ABOULDING EMERGENCY ACCESS ROUTES, FEMPORARY AND PREMIMENT WAS THE AND BUILDING EMERGENCY ACCESS ROUTES, FEMPORARY AND PREMIMENT WAS SUPPLIED, BUILDING EGRESS ROUTES, GOOD HOUSEKEPING PRACTICES, AND FIRE PROTECTION OF SYSTEM INSTALLATION AND MAINTENANCE. (GAINESVILLE FIRE PREVENTION AND PROTECTION COSTS SCIENT OF SERVENT OF THE THE PROTECTION COSTS SCIENT OF SERVENT ON THE PROTECTION COSTS SCIENT OF SERVENT OF THE PROTECTION COSTS SCIENT OF SERVENT ON THE PROTECTION COSTS SCIENT OF SERVENT OF SERVENT ON THE PROTECTION COSTS SCIENT OF SERVENT ON THE PROTECTI

NORTHWEST 1ST PLACE

LOCATION MAP

PROJECT SITE

15'±

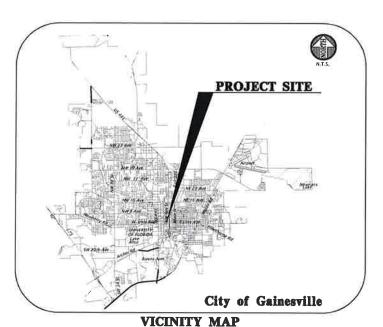
3060 PEACHTREE ROAD NW SUITE 600 ATLANTA, GA 30305 (404) 365-7600 bmahala@nilesbolton

LANDSCAPE ARCHITECT

BUFORD DAVIS, ASLA BUFORD DAVIS & ASSOCIATES 2406 NW 43RD STREET GAINESVILLE, FLORIDA 32606 (352) 335-1896

JORDAN & SKALA ENGINEERS 4275 SHCKLEFORD ROAD SUITE 200 NORCROSS, GA 30093 (770) 447-5547





GENERAL NOTES

13. THE SITE IS NOT IN A FLOOD PLAIN DISTRICT. N/A

14. THE SITE IS NOT EFFECTED BY WETLANDS REGULATIONS. N/A

15. THE SITE IS NOT LOCATED ON A NATURE PARK, GREENWAY, OR GATEWAY DISTRICT. N/A

16. THE SITE IS NOT LOCATED WITHIN THE WELLFIELDS PROTECTION DISTRICT, N/A

17. THE MAXIMUM HIGHT OF THE PROPOSED STRUCTURE IS LESS THAN 90 FEET. PER APPENDIX F SECTION R.A.2. D. THIS STRUCTURE IS WITHIN SURZONE: I, CREATER THAN 13, JODO FEET FROM THE AIRPORT, IT IS LESS THAN 100 FEET TALL, AND IS THEREFORE NOT 10 BE CONSIDERED A "POTENTIAL AIRPORT DISTRUCTION".

20. PARCEL INFORMATION:

21 BUILDING OCCUPANCY CLASS:

22 RUILDING CONSTRUCTION TYPE PER ERC-R FIETH EDITION TYPE I-A AND TYPE III-A

BASEMENT LEVEL 01 LEVEL 02 LEVEL 03 LEVEL 04 LEVEL 05 LEVEL 06 TOTAL
32,370 SF 32,600 SF 26,437 SF 26,082 SF 26,665 SF 26,665 SF 26,655 SF 26,655

25. PROPOSED USE.
THE ON SITE BUILDING WILL BE A MIXED USE, RETAIL AND MULTI-FAMILY RESIDENTIAL USE.

SHEET NUMBER	DESCRIPTION
CO.00	COVER SHEET AND INDEX
CO.10	GENERAL NOTES
C0.11	LEGEND
C0.12	CONSTRUCTION DETAILS
1 OF 2	TOPOGRAPHIC AND BOUNDARY SURVEY
CO 20	STORMWATER POLLUTION PREVENTION NOTES
C0.21	STORMWATER POLLUTION PREVENTION PLAN AND DETAILS
CO.30	DEMOLITION PLAN
CO.40	SITE REMEDIATION AND DEBRIS REMOVAL PLAN
C1.00	DEVELOPMENT PLAN AND HORIZONTAL CONTROL AND SITE PLAN
C1-20	ACCESSIBILITY SITE PLAN AND DETAILS
C2.00	DRAINAGE AND GRADING PLAN
C2.10	UNDERDRAIN LIFT STATION PLAN AND DETAILS
C2.30	STORMWATER MANAGEMENT FACILITY PLAN AND DETAILS
C3.00	UTILITY PLAN
L\$1	LANDSCAPE PLAN
EO.10	BASEMENT PARKING GARAGE INTERIOR PHOTOMETRICS
EO_11	LEVEL 01 PARKING GARAGE EXTERIOR PHOTOMETRICS
EO.12	LEVEL 01 PARKING GARAGE INTERIOR PHOTOMETRICS
EO 13	PODIUM EXTERIOR PHOTOMETRICS
E0.03	LEGENDS, NOTES, DETAILS, SCHEDULES - ELECTRICAL
E0.04	LEGENDS, NOTES, DETAILS, SCHEDULES - ELECTRICAL
A1.0.0	BASEMENT FLOOR PLAN
A1:1.0	FIRST FLOOR PLAN
A1 2.0	SECOND FLOOR PLAN
A1.3.0	THIRD FLOOR PLAN
A1.4.0	FORTH FLOOR PLAN
A1.5.0	FIFTH FLOOR PLAN
A1.6.0	SIXTH FLOOR PLAN
A1.7.0	ROOF PLAN
G.03	CODE ANALYSIS
G.04	BUILDING INFORMATION
A3.01 - A3.02	ELEVATIONS
A3.04	SITE LINES
A4 10 - A4 11	SECTIONS - BUILDING
P1 00-0	OVERALL BASEMENT FLOOR PLAN





FL PE No. 69101 C0.00

132 NW 76th Drive Gainesville, Rorida 32807 (352) 331-1976 / (352) 331-2476 www.dhv-inc.com www.dhv-inc.com CA-5075

8. THE SITE COMPLES WITH THE RORIDA BUILDING CODE FIFTH EDITION AND ALL RELATED CODES AND FLORIDA HANDICAPPED ACCESSIBILITY CODES AND STANDARDS INCLUDING THE FOLLOWING: FLORIDA BUILDING CODE - BUILDING FIFTH EDITION FLORIDA BUILDING CODE - BUISTING FIFTH EDITION FLORIDA BUILDING CODE - BUISDING THE FIBRITON FLORIDA BUILDING CODE - BUINDING FIFTH EDITION FLORIDA BUILDING CODE - BUINDING FIFTH EDITION FLORIDA BUILDING CODE - BUINDING FIFTH EDITION FLORIDA BUILDING CODE - BUENGAMENT FIFTH EDITION FLORIDA BUILDING CODE - BUENGY CONSERVATION FIFTH EDITION FLORIDA BUILDING CODE - BUENGY CONSERVATION FIFTH EDITION FLORIDA BUILDING CODE - BUENGY CONSERVATION FIFTH EDITION FLORIDA BUILDING CODE - ACCESSIBILITY FIFTH EDITION MATIONAL FLORIDA BUILDING CODE - BUENGY CONSERVATION FIFTH EDITION MATIONAL FLORIDA BUILDING CODE - BUENGY CONSERVATION FIFTH EDITION MATIONAL FLORIDA BUILDING CODE - BUENGY CONSERVATION FIFTH EDITION MATIONAL FLORIDA BUILDING CODE - BUENGY CONSERVATION FIFTH EDITION MATIONAL FLORIDA BUILDING CODE - BUENGY CONSERVATION FIFTH EDITION MATIONAL FLORIDA BUILDING CODE - BUENGY CONSERVATION FIFTH EDITION MATIONAL FLORIDA BUILDING CODE - BUENGY CONSERVATION FIFTH EDITION MATIONAL FLORIDA BUILDING CODE - BUENGY CONSERVATION FIFTH EDITION MATIONAL FLORIDA BUILDING CODE - BUENGY CONSERVATION FIFTH EDITION MATIONAL FLORIDA BUILDING CODE - BUENGY CONSERVATION FIFTH EDITION FIFTH E

19, TRAFFIC STATEMENT:
THE PROJECT TRAFFIC GENERATION IS CALCULATED FROM TRIP GENERATION RATES PUBLISHED IN THE INSTITUTE OF TRANSPORTATION ENGINEERS (ITE) TRIP GENERATION, AN INFORMATIONAL REPORT, 9TH EDITION.

	QUANTITY	ADT	PM PEAK HR
EXISTING LAND USE SPECIALTY RETAIL (826)	7,000	310	19
PROPOSED LAND USE APARTMENTS (220) SPECIALTY RETAIL (826)	168 PERSONS 4,000	556 177	67
NET TOTAL (AFTER 40% REDUCTION)		254	16

THE DEVELOPMENT IS LOCATED IN ZONE. A OF THE TRANSPORTATION MOBILITY ELEMENT PROGRAM AREA (THIPM), AND SHALL MEET ALL CRITERIA AS LISTED IN THE THE TIMPA POLICY 10.1.4 AND 10.1.1.4 DEVELOPER AGREES TO SATISFY MOBILITY CRITERIA VIA CASH-PAYMINT AN ELEO OF THE CRITERIA. THE DEVELOPMENT WILL COMMY'S WITH POLICIES 10.1.4 AND 10.1.1 OF THE TRANSPORTATION MOBILITY ELEMENT. DEVELOPER AGREES TO SATISFY THE PROVISIONS OF POLICY 10.1.14 BY MAKING A TRANSIT PAYMENT TO FUND THE CAPITAL TRANSPORTATION THAN STATEMENT TO FUND THE

DWELLING: R2, CLUBROOM A-3, COMMERCIAL TBD, PARKING: S-2

CHEER DIDEN

24 BUILDING HEIGHT: PER FBC 2015 - 89'-2"

2. THE LOCATION OF ALL EXISTING UTILITIES SHOWN ON THE PLANS HAS BEEN DETERMINED FROM THE BEST INFORMATION AVAILABLE. THE ENCINEER ASSUMES NO RESPONSIBILITY FOR ACCURACY. IT SHALL BE THE CONTRACTOR'S RESPONSIBILITY TO NOTIFY THE VARIOUS UTILITIES AND TO MAKE NECESSARY ARRAINGEMENTS FOR ANY PREDICATION OF THESE UTILITIES WITH THE OWNER OF THE UTILITY. THE CONTRACTOR SHALL EXERCISE CAUTION WHEN CROSSING ANY UNDERGROUND UTILITY, WHETHER SHOWN ON THE PLANS OR LOCATED BY THE UTILITY. THE CONTRACTOR SHALL EXERCISE CAUTION UTILITY COMMAINES SHALL RELOCATE ALL UTILITIES THAT INTERFERE WITH THE PROPOSED CONSTRUCTION. THE CONTRACTOR SHALL COOPERATE WITH THE UTILITY COMMAINES DURING THE RELOCATION OPERATIONS. ANY DELAY OR INCONVENIENCE CAUSED TO THE CONTRACTOR SY THE VARIOUS UTILITIES SHALL BE INCIDENTAL TO THE CONTRACT AND NO EXTRA COMPENSATION WILL BE ALLOWED.

3, THE CONTRACTOR SHALL EXERCISE EXTREME CAUTION IN AREAS OF BURIED UTILITIES AND SHALL PROVIDE AT LEAST 48 HOURS NOTICE TO THE APPROPRIATE UTILITY COMPANIES IN ORDER TO ALLOW MARKING OF THE LOCATIONS OF EXISTING UNDERGROUND FACILITIES IN ADVANCE OF CONSTRUCTION BY CALLING THE FLORIDA SURSHINE STATE ONE CALL CENTER, INC. AT 1-800-324-2770 OR IT: ITS THE CONTRACTORS RESPONSIBILITY TO NOTIFY SUNSHING-38 HOURS PRIOR TO ANY CLEARING OF CONSTRUCTION TO IDENTIFY ALL UTILITY LOCATIONS, NO CONSTRUCTION ACTIVITY WAY OCCUR UNIT. THE UTILITIES HAVE BEEN PROPERLY MARKED.

4. THE CONTRACTOR SHALL FIELD VERIFY THE HORIZONTAL LOCATION AND VERTICAL LOCATION OF ALL DISTING UTILITIES WITHIN THE LIMITS OF THE PROJECT ENVELORE SHOWN PRIOR TO COMMERCING WORK. THE CONTRACTOR SHALL CALL ALL UTILITY COMPANIES TO HAVE THE LOCATIONS OF ALL UTILITIES FIELD MARKED PRIOR TO COMMENDENT OF CONSTRUCTION. ANY DISCREPANCES SHALL BE RENOUGHT TO THE ATTENTION OF THE ENGINEER PRIOR TO CONTINUING CONSTRUCTION

HE CONTRACTOR IS RESPONSIBLE FOR REPAIRING ANY DAMAGE TO EXISTING FACILITIES. ABOVE OR BELOW GROUND THAT MAY OCCUR AS A RESULT

6. ALL PRIVATE AND PUBLIC PROPERTY AFFECTED BY THIS WORK SHALL BE RESTORED TO A CONDITION EQUAL TO OR BETTER THAN EXISTING CONDITIONS BEFORE COMMENCING CONSTRUCTION WORK, UNLESS SPECIFICALLY EXEMPTED BY THE PLANS. ADDITIONAL COSTS ARE INCIDENTAL TO OTHER CONSTRUCTION AND ON EXTRA COMPENSATION WILL BE ALLOWED.

7. ALL WORK PERFORMED SHALL COMPLY WITH THE REGULATIONS AND ORDINANCES OF THE VARIOUS GOVERNMENTAL AGENCIES HAVING JURISDICTION OVER THE WORK INCLUDING LANDSCAPING.

8. IT IS THE CONTRACTOR'S RESPONSIBILITY TO BECOME FAMILIAR WITH THE PERMIT AND INSPECTION REQUIREMENTS OF THE VARIOUS GOVERNMENTAL AGENCIES. THE CONTRACTOR SHALL OBTAIN ALL NECESSARY PERMITS PRIOR TO CONSTRUCTION AND SCHEDULE INSPECTIONS ACCORDING TO AGENCY AND/OR MUNICIPALITY INSTRUCTIONS.

9. IT SHALL BE THE SOLE RESPONSIBILITY OF THE CONTRACTOR TO COMPLY WITH AND ENFORCE ALL APPLICABLE SAFETY REGULATIONS

10. THE CONTRACTOR SHALL BE RESPONSIBLE FOR PROTECTING EXCAVATIONS AGAINST COLLAPSE AND SHALL PROVIDE BRACING, SHEETING OR SHORING AS NECESSARY. TRENCHES SHALL BE KEPT DRY WHILE PIPES ARE BEING PLACED. DEWATERING SHALL BE USED AS REQUIRED, AND PERMITTED THROUGH LOCAL GOVERNMENTAL AGENCIES AND WATER MANAGEMENT DISTRICT PER CURRENT REQUIATIONS AT THE SOLE COST OF THE

11 CONTRACTOR TO REVIEW GEOTECHNICAL REPORT AND BORINGS PRIOR TO BIDDING THE PROJECT AND FOLLOW OUTLINED CONSTRUCTION TECHNICIUS

12 THE CONTRACTOR IS RESPONSIBLE FOR COORDINATING APPLICABLE TESTING WITH THE SERVICES OF AN APPROVED TESTING LABORATORY AND/OR IS THE CUSTAME. LIGHT REPORTED FOR COLUMNIATION APPLICABLE TESTING, WITH THE SERVICES OF AN APPRICABLE TO LINK, LABORALING AND ASSOCIATIONS.
SOLIS ENGINEER, APPLICABLE RECULATIONS ACCOUNTED AN AM YE FOUND IN THE ENGINEERING CONSTRUCTION DRAWNINGS OF SECIFICATIONS.
SOLIS ENGINEER, LABORATORY ALL TESTING WITH THE OWNER PRIOR TO COMMERCING CONSTRUCTION. JUPON COMPLETION OF THE WORK, THE TESTING.
LABORATORY ANDOOR SOLIS ENGINEER MUST SUBMIT TO THE OWNERS SENGINEER CERTIFICATIONS STATING THAT ALL REQUIREMENTS HAVE BEEN MET.

13. INSTALL SILT FENCE PRIOR TO SITE DEMOLITION OR NEW SITE CONSTRUCTION. INSTALL SILT FENCE PER FLORIDA STORMWATER EROSION AND SEDIMENTATION CONTROL INSPECTOR'S MANUAL AND PROVIDE TOE IN. THE CONTRACTOR SHALL MAINTAIN THE SILT FENCE IN WORKING ORDER THROUGHOUT THE CONSTRUCTION PHASE. THE PROJECT SILT FENCE SHALL BE INSPECTED DAILY AND ANY CORRECTIVE MEASURES SHALL BE

14, ALL TREE BARRICADES AND SILT FENCING SHALL BE INSTALLED AND INSPECTED BY ALACHUA COUNTY ENVIRONMENTAL PROTECTION DEPARTMENT PRIOR TO COMMENCEMENT OF ANY DEMOLITION OR CONSTRUCTION ACTIVITIES.

15. THE CONTRACTOR IS TO PREPARE THE SITE PRIOR TO BEGINNING ACTUAL CONSTRUCTION IN ACCORDANCE WITH THE GEOTECHNICAL REPORT.

16. ALL DELETERIOUS MATERIAL (I.E. MUCK, PEAT, BURIED DEBRIS) IS TO BE EXCAVATED IN ACCORDANCE WITH THESE PLANS OR AS DIRECTED BY THE OWNER'S ENCINEER OR OWNER'S SOIL TESTING COMPANY. DELETERIOUS MATERIAL IS TO BE STOCKPILED AND REMOVED FROM THE SITE. EXCAVATEL AREAS ARE TO BE BACKFILLED WITH APPROVED MATERIALS AND COMPACTED AS FOHOW ON THESE AREAS.

17. CONTRACTOR SHALL CLEAR AND GRUB ONLY THOSE PORTIONS OF THE SITE NECESSARY FOR CONSTRUCTION, DISTURBED AREAS SHALL RESORDED. SEEDED, MULCHED, OR PLANTED WITH OTHER APPROVED LANDSCAPE MATERIAL, AS DIRECTED BY THESE PLANS, IMMEDIATELY FOLLOWIN CONSTRUCTION PER LOCAL INSPECTOR.

18. WORK BEING PERFORMED UNDER THIS CONTRACT SHALL INTERFACE SMOOTHLY WITH OTHER WORK BEING PERFORMED ON THE SITE BY OTHER CONTRACTOR'S AND/OR UTILITY COMPANIES. IT WILL BE NECESSARY FOR THE CONTRACTOR TO COORDINATE AND SCHEDULE HIS ACTIVITIES, WHERE NECESSARY WITH OTHER CONTRACTORS AND UTILITY COMPANIES.

19. ALL PAVEMENT DIMENSIONS SHOWN ARE TO EDGE OF PAVEMENT UNLESS OTHERWISE NOTED

20 THE GOVERNING STANDARDS AND SPECIFICATIONS SHALL BE PER CITY OF GAINESVILLE PUBLIC WORKS CONSTRUCTION AND INSPECTION

21. ALL NEW TRAFFIC CONTROL DEVICES (SIGNS AND PAVEMENT MARKINGS) SHALL CONFORM TO THE MANUAL ON UNIFORM TRAFFIC CONTROL DEVICES (MUTCD) AND FDOT STANDARDS.

22 CONTRACTOR IS RESPONSIBLE FOR MAINTAINING PROPER BENCHMARKS ON SITE. EXISTING BENCH MARKS SCHEDULED FOR REMOVAL SHALL BE RELOCATED AT CONTRACTORS EXPENSE AND RE-ESTABLISHED BY A LICENSED SURVEYOR.

23. ALL HANDICAP RAMPS SHALL COMPLY WITH THE FLORIDA ACCESSIBILITY CODE AND AMERICANS WITH DISABILITY'S ACT.

24. A PRE-CONSTRUCTION CONFERENCE SHALL BE REQUIRED. THE CONTRACTOR, ENGINEER OF RECORD, AND THE OWNER SHALL MEET WITH THE ALACHUA COUNTY PUBLIC WORKS DEPARTMENT PRIOR TO INITIATION OF SITE CONSTRUCTION.

25. ANY CHANGE ORDER REQUESTS. SITE REVISIONS, AND PAY REQUESTS MUST BE SUBMITTED TO AND APPROVED BY THE ENGINEER OF RECORD

26. CONTRACTOR IS RESPONSIBLE FOR ALL DEWATERING AS NEEDED THROUGHOUT ALL CONSTRUCTION ACTIVITIES COVERED BY THESE PLANS. DEWATERING SHALL BE DONE IN ACCORDANCE WITH FDOT STANDARD SPECIFICATIONS, 2014 EDITION, SECTION 120.

27. THE CONTRACTOR IS RESPONSIBLE FOR THE PERFORMANCE AND COST OF ALL CLEARING AND GRURRING AND ALL WORK OF REMOVAL DISPOSAL AND REPAIR OR REPLACEMENT OF EXISTING IMPROVEMENTS WHERE SHOWN IN THE PLANS, OR ORDERED BY THE ENGINEER TO BE REMOVED, OR W REQUIRED BECAUSE OF THE CONSTRUCTION OPERATIONS, IN ORDER TO CONSTRUCT THE PROPOSED IMPROVEMENTS (THIS INCLUDES BUT IS NOT LIMITED TO PROPOSED PIPING, STRUCTURES, UTILITIES, PAVING, CURBING, ETC.)

I AS-BUILT SURVEY MAY BE REQUIRED BY REGULATORY AGENCIES. CONTRACTOR TO COORDINATE WITH PROJECT OWNER FOR COMPLETION OF ILT SURVEYS PRIOR TO PROJECT / PERMIT CLOSE-OUT.

29. ALL WORK WITHIN OR ON CITY OWNED OR MAINTAINED FACILITIES, ROW OR EASEMENT WILL REQUIRE AS BUILT PLANS. AS-BUILT PLANS SHOULD SHOW THE CONSTRUCTED CONDITIONS OF THE CITY OWNED OR MAINTAINED PACE AND BE PERFORMED BY A FORIDA LICENSED PROFESSIONAL SURVEYOR AND MAPPER. REQUIREMENTS FURTHER DESCRIBED AS PER THE CITY OF CAINESVILLE DESIGN AND CONSTRUCTION MANUAL (CURRENT EDITION) SECTION B.3.

MAINTENANCE OF TRAFFIC (MOT) NOTES

1. THE CONTRACTOR IS RESPONSIBLE FOR CREATING A MAINTENANCE OF TRAFFIC (MOT) PLAN FOR THE PUBLIC RIGHT-OF-WAY, INCLUDING BUT NOT LIMITED TO SIDEWALK WORK AND ACTIVITIES THAT REQUIRE A LANF (OR ROAD) CLOSURE SIJICH AS THE FUEL MOTH TO SEWER MANHOLES AND WATER MILLE OF SIDEMALK WORK AREA ALTIVITIES THAT REQUIRE A UTILE ROOM RECORD TO SEWER MANHOLES AND WATER MINS. THE MOT PLAN MUST BE CREATED BY A REGISTERED PROFESSIONAL ENGINEER WHO IS CERTIFIED TO DO SO BY THE FOOT MOT CERTIFICATION TRAINING. THE MOT PLAN MUST ALSO BE IN ACCORDANCE WITH FOOT DESIGN STANDARDS AND FOOT STANDARDS AND FOOT STANDARDS STREICHTATIONS REQUIREMENTS AND MUST BE REVIEWED AND APPROVED BY THE FOOT.

2. THE CONTRACTOR SHALL SUBMIT THE MOT TO THE APPROPRIATE REGULATORY AUTHORITY PRIOR TO WORK REQUIRING THE MOT FOR APPROVAL. NO WORK IN THE ROW SHALL OCCUR UNTIL THE MOT IS APPROVED.

DEMOLITION GENERAL NOTES

2. REMOVE ALL IMPROVEMENTS DEFINED ON THE DEMOLITION PLAN. SALVAGE ITEMS TO OWNER AS DEFINED BY THE OWNER'S REPRESENTATIVE AND CONSTRUCTION DOCUMENT SPECIFICATIONS.

3. EXISTING PAVEMENT AND SIDEWALK EDGES THAT BORDER NEW CONSTRUCTION OR DEMOLITION ARE TO BE SAW-CUT TO PROVIDE A SMOOTH TRANSITION

4. ALL EXISTING TREES ARE TO REMAIN UNLESS OTHERWISE NOTED.

5. ROOTS LARGER THAN 1 INCH IN DIAMETER ON TREES TO BE PRESERVED THAT ARE ENCOUNTERED DURING CONSTRUCTION MUST BE CUT CLEANLY AND COVERED OVER WITH SOIL BY THE FND OF THE WORKING DAY

6. ALL ASPHALT AND LIMEROCK WILL BE COMPLETELY REMOVED FROM AREAS THAT WILL BE LANDSCAPED, IN PARTICULAR, AREAS WHERE ASPHALT WILL BE REMOVED MUST HAVE THE TOP HARD SURFACE, LIMEROCK, AND COMPACTED SOIL REMOVED. REPLACEMENT SOIL SHALL BE CLEAN DEEP FILL OF PH 5.5 - 6.5. THE DEPTH OF UNCOMPACTED SOIL PROKEN TO PLANTING MUST BE AT LEAST 3 FEET TO ACCOMMODATE FUTURE TREE ROOT GROWTH. NO LIMEROCK, LARGE STONES, OR OTHER CONSTRUCTION DEBRIS CAN REMAIN IN AREAS TO BE LANDSCAPED.

PAVING, GRADING, AND DRAINAGE GENERAL NOTES

1. THE CONTRACTOR IS RESPONSIBLE FOR EROSION/SEDIMENTATION CONTROL PRACTICES DURING CONSTRUCTION TO MINIMIZE ON-SITE EROSION/SEDIMENTATION AND TO PROTECT AGAINST DAMAGE TO OFF SITE PROPERTY. THE FOLLOWING PRACTICES SHALL BE EMPLOYED.

A. EROSION AND SEDIMENTATION CONTROL SHALL BE THE RESPONSIBILITY OF THE CONTRACTOR. AREAS OF OFF-SITE DISCHARGE DURING CONSTRUCTION SHALL BE PROTECTED WITH A SEDIMENT BARRIER PER FLORIDA STORMWATER EROSION AND SEDIMENTATION CONTROL INSPECTOR'S MANUAL TO PREVENT OFF-SITE DISCHARGE OF SEDIMENTS. A SILT BARRIER SHALL SPECIFICALLY BE REQUIRED, CONSTRUCTED, AND MAINTAINED AS INDICATED ON THIS SHEET. TEMPORARY SEED AND MILICH SHOULD BE USED TO CONTROL ON-SITE EROSION WHEN IT IS NOT PRACTICAL TO ESTABLISH PERMANENT VEGETATION, SOD SHALL BE PLACED AS EARLY AS POSSIBLE ON ALL SLOPES STEEPER THAN 5 (FT) HORIZONTAL TO 1 (FT) VERTICAL, SOL SHALL BE PINNED AS REQUIRED. ALL EROSION AND SEDIMENTATION CONTROL MEASURES SHALL BE MAINTAINED IN WORKING ORDER THROUGHOUT CONSTRUCTION PHASE. THE CONTRACTOR SHALL INSPECT AND REPAIR AS NECESSARY THE EROSION/SEDIMENTATION PROTECTION AT THE END OF EACH WORKING DAY.

NOTE: EROSION/SEDIMENTATION CONTROL SHALL BE PLACED PRIOR TO SITE EXCAVATION AND SHALL REMAIN IN PLACE UNTIL SITE VEGETATION AND

B. ALL INLET STRUCTURES AND PIPE SHALL BE PROTECTED FROM SILTATION BY CONSTRUCTING INLET PROTECTION AS DEFINED BY THESE PLANS OR IN THE FOOT STANDARDS. IF SILTATION OCCURS, THE CONTRACTOR IS RESPONSIBLE TO REMOVE SILTATION AS PART OF THE BASE CONTRACT AT NO ADDITIONAL COST TO THE OWNER.

C. UNDERGROUND EXCAVATED STORMWATER FACILITIES SHALL BE CONSTRUCTED AS PART OF THE INITIAL CONSTRUCTION. THE FACILITIES SHALL BE NSTALLED TO THE DESIGN ELEVATIONS. AFTER THE CONTRIBUTING DRAINAGE AREA IS STABILIZED, EXCESS AND UNSUITABLE SOILS SHALL BE REMOVED FROM THE BASIN (REMOVE ALL ACCUMULATED SILTS, CLAYS, ORGANIC, AND DEBRIS).

D. PERMANENT VEGETATIVE STABILIZATION SHALL BE APPLIED ON FINE GRADED SITES AS SOON AS PRACTICAL, TEMPORARY SEEDING SHOULD BE EMPLOYED TO PREVENT EXPOSURE OF BARREN SOILS UNTIL PERMANENT VEGETATION CAN BE APPLIED.

E. ALL SLOPES 1:3 OR STEEPER REQUIRE LAPPED OR PEGGED SOD.

F. EROSION, SEDIMENT AND TURBIDITY CONTROL ARE THE RESPONSIBILITY OF THE CONTRACTOR, THESE DELINEATED MEASURES ARE THE MINIMUM REQUIRED, WITH ADDITIONAL CONTROLS TO BE UTILIZED AS NEEDED, DEPENDENT UPON ACTUAL SITE CONDITIONS AND CONSTRUCTION OPERATIOI

G. ALL SYNTHETIC BALES, SILT FENCE, AND OTHER EROSION CONTROL MEASURES SHALL BE REMOVED AT THE COMPLETION OF THE PROJECT.

2. THE CONTRACTOR SHALL MAINTAIN IN HIS POSSESSION A COPY OF THE WATER MANAGEMENT DISTRICT CONSTRUCTION PERMIT. HE SHALL BE RESPONSIBLE FOR ADHERENCE TO ALL CONDITIONS CONTAINED IN THE PERMIT.

3. PROPOSED SPOT ELEVATIONS REPRESENT FINISHED PAVEMENT OR GROUND SURFACE GRADE UNLESS OTHERWISE NOTED ON DRAWINGS

4. CONTRACTOR SHALL SUBMIT FOR REVIEW TO THE OWNER AND OWNER'S ENGINEER SHOP DRAWINGS ON ALL PRECAST AND MANUFACTURED ITEMS TO BE USED ON THIS SITE. FAILURE TO OBTAIN APPROVAL BEFORE INSTALLATION MAY RESULT IN REMOVAL AND REPLACEMENT AT CONTRACTOR'S EXPENSE. ENGINEER'S APPROVAL OF A SHOP DRAWING DOES NOT RELIEVE THE CONTRACTOR'S RESPONSIBILITY FOR THE PERFORMANCE OF THE ITEM.

THE COST OF ALL TESTING OF COMPACTION AND OTHER REQUIRED TESTS SHALL BE PAID BY THE CONTRACTOR AND MADE AVAILABLE TO THE

6. GENERAL CONTRACTOR TO CONTACT ENGINEER OF RECORD AND THE OWNER REPRESENTATIVE 48 HOURS IN ADVANCE PRIOR TO BACKFILLING TRENCHES FOR FIELD INSPECTION AND PRIOR TO LAYING ASPHALT FOR FIELD INSPECTION.

7. CONTRACTOR IS TO SUBMIT FOOT APPROVED ASPHALT DESIGN MIXES TO THE OWNER'S REPRESENTATIVE AND ENGINEER OF RECORD BEFORE ANY WORK IS TO COMMENCE ON PROJECT. THE MIXTURE AT THE PLANT OR ON THE ROAD SHALL NOT EXCEED 335 DEGREES. THE CONTRACTOR SHALL NOTIFY THE OWNER'S REPRESENTATIVE AND PROVIDE TEMPERATURE READINGS PRIOR TO LAVING ASPHALT.

8. AS DETERMINED NECESSARY AND DIRECTED BY CITY OF GAINESVILLE PUBLIC WORKS DEPARTMENT OR ENGINEER OF RECORD, THE CONTRACTOR SHALL UNDERCUT ALL UNSUITABLE MATERIAL 24 INCHES BELOW THE BOTTOM OF ANY PROPOSED LIMEROCK BASE, AND SHALL BACKFILL WITH FILL MATERIAL MEETING FOOT STANDARD SPECIFICATIONS FOR ROAD AND BRIDGE CONSTRUCTION. SEE FOOT INDEX NO. 500 AND 505

9. PROVIDE LEVEL PLATFORM IN FRONT OF ALL EGRESS DOORS. THE FLOOR SURFACE ON BOTH SIDES OF A DOOR SHALL BE AT THE SAME FLEVATION THE FLOOR SURFACE OR LANDING ON EACH SIDE OF THE DOOR SHALL EXTEND FROM THE DOOR IN THE CLOSED POSITION A DISTANCE EQUAL TO TH DOOR WIDTH AND SHALL COMPLY WITH SECTION 4.13.6 MANEUVERING CLEARANCES AT DOORS OF THE FLORIDA ACCESSIBILITY CODE FOR BUILDING

10. REFER TO FDOT INDEX 304 FOR CURB RAMP DESIGN.

11 THE CONTRACTOR SHALL STOCKPILE TOPSOIL AND CONSTRUCTION MATERIALS IN AREAS DESIGNATED BY THE OWNER.

12 THE CONTRACTOR IS RESPONSIBLE FOR PROVIDING RECORD DRAWINGS OR AS-BUILT SURVEY AS NOTED IN NOTE #28 UNDER SITE GENERAL NOTES.

14. ALL WELLS, CLEANOUTS, MANHOLE TOPS, PULL BOX COVERS AND OTHER UTILITY APPURTENANCES IN THE AREA OF REDEVELOPMENT SHALL BE PROTECTED AND TOPS ADJUSTED TO MATCH PROPOSED GRADES.

15. CONTRACTOR SHALL SAW CUT, TACK, AND MATCH EXISTING PAVEMENT AT LOCATIONS WHERE NEW PAVEMENT MEETS ANY EXISTING PAVEMENT.

16. SOD SHALL BE PLACED AROUND ALL STRUCTURES AS DIRECTED BY THE FDOT INDEX NO. 281. ALL OTHER DISTURBED AREAS SHALL BE SEEDED

17. ALL STORM SEWER CURB AND DITCH BOTTOM INLETS SHALL CONFORM TO THE APPLICABLE FDOT INDEX. ALL DRAINAGE STRUCTURES WITH GRATES THAT ARE LOCATED IN GRASSED AREAS SHALL HAVE THE GRATE CHAINED TO THE STRUCTURE USING AN EYE BOLT AND CHAIN.

18. ALL CONCRETE STRUCTURES SHALL HAVE ALL EXPOSED EDGES CHAMFFRED 3/4" AND CLASS I SURFACE FINISH 19. ALL HDPE FITTINGS AND CONNECTORS SHALL BE SOIL TIGHT. SEE SPECIFICATIONS FOR MORE INFORMATION.

20. COMPACTION OF ALL MATERIALS SHALL BE LIMITED TO STATIC MODE ONLY, UNLESS DIRECTED OTHERWISE BY THE ENGINEER OR RECORD

21. ALL RCP PIPE IOINTS SHALL BE WRAPPED WITH FILTER FABRIC IN ACCORDANCE WITH FDOT STANDARD SPECIFICATION SECTION 430.

CITY OF GAINESVILLE NOTES

1. All work within or on City owned or maintained facilities, ROW or easement will require as-built plans. As-built plans should show the constructed conditions of the City owned or maintained ense and be performed by a Fioritia Licansed Professional Surveyor and Mapper. The Contractor shell provide the City with an as-built survey of the retention / detention basis and associated structures, prepared by a registered land surveyor. The survey shall be submitted on paper copy and electronically (pdf autodesk CAO) Any construction in the City of Gainusville Public ROW will require permits from the Public Works Department prior to beginning work.

2. A MOT permit is required for any activity in the ROW the either directly or indirectly affects vehicular or pedestrian traffic.

3. Open cut restoration shall be performed in accordance with FDOT index 307 and using the flowable fill ontion.

GRU UTILITY NOTES

2. THE UTILITY PLAN AND PLAT SHOWS ALL PUBLIC UTILITY EASEMENTS (PUE'S) IN A METES AND BOUNDS FORMAT. UPON CRU'S APPROVAL OF PLANS FOR DEVELOPMENTS NOT BEING PLATTED, OWNER MAY CHOOSE TO GRANT THE METES AND BOUNDS EASEMENTS AS SHOWN, OR A BLANKET CASEMENT OWER THE ENTIRE PROPERTY, PROVIDED FACILITIES ARE INSTALLED WITHIN THE PRESCRIBED DISTANCES AS SHOWN ON THE UTILITY PLANS AND IN ACCORDANCE WITH THE UTILITY SEPARATION REQUIREMENTS TABLE IN APPENDIX C OF THE GRU W/WW/RCW DESIGN STANDARDS.

3. ALL CONSTRUCTION MATERIALS AND METHODS FOR POTABLE WATER, WASTEWATER, AND RECLAIMED WATER SYSTEMS SHALL CONFORM TO GRU'S MOST RECENT POTABLE WATER, WASTEWATER, & RECLAIMED WATER SYSTEM DESICN STANDARDS AND APPROVED MATERIALS MANUAL,

4. POTABLE WATER AND WASTEWATER MAINS SHALL MAINTAIN A MINIMUM 10 FEET HORIZONTAL AND 1.5 FOOT VERTICAL SEPARATION.

5, A MINIMUM HORIZONTAL SEPARATION OF 10 FEET FOR POTABLE WATER MAINS, WASTEWATER FORCE MAINS, AND RECLAIMED WATER MAINS, AND 15 FEET FOR GRAVITY WASTEWATER MAINS SHALL BE PROVIDED AND MAINTAINED FROM BUILDINGS, TRANSFORMERS, AND ALL PERMANENT STRUCTURES. SERVICE LATERALS REQUIRE 5 FEET LESS CLEARANCE FOR EACH OF THE UTILITIES. NOTE THAT WATER SERVICE LATERALS SHALL BE INSTALLED WITHIN 3" SLEEVES, ISEE APPENDIX C OF GRUYS DESIGN STANDARDS AND CONSTRUCTION DETAILS FOR POTABLE WATER, WASTEWATER, AND RECLAIMED WATER IZONTAL SEPARATION DISTANCES FOR PARALLEL AND PERPENDICULAR CLEARANCE FROM OTHER OBJECTS TABLE.)

6. POTABLE WATER SERVICES, REQUIRING A SEPARATE WATER METER, SHALL BE PROVIDED TO EACH LOT, BUILDING OR PARCEL, EFFECTIVE OCTOBER 1, 2007, FOR COMMERCIAL, MULTIFAMILY, AND INSTITUTIONAL DEVELOPMENTS, THE DEVELOPER SHALL BE RESPONSIBLE FOR INSTALLING POTABLE WATER SERVICES AND VOKE ASSEMBLY PACKAGE UP TO AND INCLIDION THE METER YOKE, BOX (INSTALLED AT FINAL GRAD) AND ASSOCIATED APPURTENANCES, FOR METERS 1" AND SMALLER (SEE GRU W/WW/RCW CONSTRUCTION DETAIL W - 8,0), WITH A ONE-YEAR WARRANTY.

7. 2" VALVES LOCATED IN PAYED AREAS, INCLUDING SIDEWALKS, SHALL BE GRU APPROVED CAST IRON, RESILIENT SEAT GATE VALVES WITH STANDARD 2" OPERATING NUT, THREADED WITH BRASS NIPPLE BETWEEN THE VALVES AND TAPPING SADDLE OR TAPPED TEE.

8. WATER MAINS 4" IN DIAMETER AND GREATER, PLACED UNDER ROADWAYS, SHALL BE CEMENT LINED DUCTILE IRON PIPE (CLDIP) EXTENDING 5 FEET PAST THE BACK OF CURB (3 FEET WITHIN CITY OF GAINESVILLE LIMITS). TRACER WIRE INSTALLED ON PVC WATER MAINS SHALL CONTINUE ACROSS THE CLDIP SECTIONS.

9, 1 " OR 2 " WATER SERVICE CROSSINGS LOCATED UNDER ROADWAYS SHALL BE ENCASED IN 3 " SCH 40 PVC EXTENDING S' PAST THE BACK OF CURB (3 FEET INSIDE CITY OF GAINESVILLE LIMITS

10. ANCHORING TEES. COUPLINGS, AND BENDS SHALL BE USED ON ALL FIRE HYDRANT ASSEMBLIES.

11. ALL PRESSURIZED MAIN FITTINGS SHALL BE MECHANICAL JOINT WITH RESTAINED JOINT GLANDS, A SUFFICIENT LENGTH OF THE PIPE CONNECTED TO THE FITTINGS SHALL BE MECHANICALLY RESTRAINED TO PROVIDE REACTION AS SPECIFIED ON THE RESTRAINED JOINT STANDARD IN THE CONSTRUCTION DETAILS OF THE GRU STANDARDS (W. 2.8 & 2.9. RCW - 2.8 & 2.9. AND WW - 2.4 & 2.5). CALCULATIONS FOR REQUIRED RESTRAINT LENGTH MUST BE PROVIDED IF THE SPECIFIED RESTRAINT LENGTH, DUE TO SOIL TYPE OR DEPTH OF COVER, DIFFERS FROM THOSE PROVIDED ON THESE DETAILS.

12 ALL SANITARY WASTEWATER SERVICE LATERALS SHALL BE MIN. 4" DIAMETER PVC (SDR 35) AT 1 00% MIN. SLOPE UNLESS OTHERWISE LABELED

13, WASTEWATER CLEANOUT COVERS LOCATED WITHIN PAVEMENT AND SIDEWALKS ADJACENT TO PAVED AREAS SHALL BE RATED FOR TRAFFIC LOAD BEARING, WASTEWATER CLEANOUT COVERS IN OTHER SIDEWALKS/WALKWAYS SHALL BE BRASS WITH A SQUARE RECESS.

14. MANHOLES WHICH ARE NOT INSTALLED UNDER PAVEMENT SHALL HAVE A RIM ELEVATION AT LEAST 6" ABOVE FINISHED GRADE, AND A 10:1 SLOPE TO FINISHED GRADE.

I S., UNLESS OTHERWISE NOTED ON THE PLANS, THE FINISHED FLOOR ELEVATIONS OF BUILDINGS SHALL BE A MINIMUM OF 6 " ABOVE THE LOWEST UPSTREAM MANHOLE TOP. IF THIS IS INFEASIBLE, A WASTEWATER SERVICE LATERAL BACKWATER VALVE (BWV) IS REQUIRED ON THE CUSTOMER SIDE OF

16. WHEN A POTABLE OR RECLAIMED WATER MAIN, OR A WASTEWATER FORCE MAIN IS ROUTED WITHIN 10 FT. OF AN ELECTRIC TRANSFORMER, FT. LENGTH OF DIP SHALL BE CENTRED ON THE TRANSFORMER WITH MECHANICAL RESTRAINT AF EACH FID. NO FITTINGS OR NALVES SHALL OW WITHIN 10 FT. OF THE MEARSTS DEGE OF THE TRANSFORMER, A MINIMUM CLEARANCE OF 3' SHALL BE MAINTAINED.

ELECTRIC SERVICE GENERAL NOTES

1. ALL ELECTRICAL UTILITIES AND INFORMATION SHOWN ON THE CIVIL PLANS ARE FOR LOCATION AND COORDINATION PURPOSES ONLY. REFER TO ELECTRICAL PLANS BY OTHERS FOR THE ELECTRICAL DESIGN AND DETAILS.

2 ELECTRIC DESIGN PROVIDED BY GRU ENERGY DELIVERY

132 NW 76th Drive Gainesville, Frortis 23607 (382) 331-1976 (382) 331-3476 wst. 1898 FLORIDA est. 1898 FLORIDA CA-5075

ENOIT INCE

FL PE No. 69101

CO.10

	ABBREV	<u>TAT</u>		SIGNAGE
	FEET (WHEN USED WITH LENGTHS)	N	N NORTH	SIGNS ARE PER FDOT SPECIFICATIONS OR PER MUT POSTS AND INSTALLATION SHALL BE PLA FDOT IN
	DEGREES MINUTES (WHEN USED WITH ANGLES)	N E N/A	NORTHING = EASTING NOT APPLICABLE	11860, SIGN PLACEMENT SHALL BE PER FDOT IND 17302
	SECONDS	NAVD	NORTH AMERICAN VERTICAL DATUM OF 1988	
% ©	PERCENT AT	NGVD	NATIONAL GEODETIC VERTICAL DATUM OF	TTP 20 06 (12° X 18°) PER FDOT II
(Jan	Ai .	NO	NUMBER	12355
0.000		NPDES	NATIONAL POLLUTANT DISCHARGE ELIMINATION SYSTEM	
AASHI	TRANSPORTATION OFFICIALS	NTS	NOT TO SCALE	$\overline{}$
AC ADA	ACRES AMERICAN WITH DISABILITIES ACT		0	R1-1 "STOP" - SEE PLANS FOR SIZE
ANSI	AMERICAN NATIONAL STANDARDS INSTITUTE	oc	ON CENTER	(6 1 Ab)
ARCH	ARCHITECT	OHW	OVERHEAD WIRE OFFICIAL RECORDS BOOK	
ARV ASTM	AIR RELEASE VALVE AMERICAN SOCIETY FOR TESTING AND	ORB OSHA	OCCUPATIONAL SAFETY AND HEALTH	
	MATERIALS		ADMINISTRATION	
AWWA	AMERICAN WATER HORKS ASSOCIATION		P	
	8	PAVT	PAVEMENT	
BC BFP	BACK OF CURB BACKFLOW PREVENTER	PCC PCC	POINT OF CURVATURE POINT OF COMPOUND CURVE	
BLDG	BUILDING	PERF	PERFORATED	
8M 8MP	BENCHMARK BEST MANAGEMENT PRACTICE	PROP PT	PROPOSED POINT OF TANGENCY	
BOC	BACK OF CURB	PVC	POLYVINYL CHLORIDE	
BVCS	BEGIN VERTICAL CURVE STATION	PVI	POINT OF VERTICAL INTERSECTION	
BVCE BW	BEGIN VERTICAL CURVE ELEVATION BOTTOM OF WALL			
BSL	BUILDING SETBACK LINE	R	RADIUS	
		RCP RPM	REINFORCED CONCRETE FIFE	
CATV	C CABLE TELEVISION	RPM RPZ	RAISED REFLECTIVE PAVEMENT MARKER REDUCED PRESSURE ZONE	
CI	CURB INLET	RT	RIGHT	
CIP	CAST IRON PIPE	RWM 8/W	RICHT-OF-WAY	
CMP CO	CORRUGATED METAL PIPE CLEANOUT	N/W	AIGHT OF WAT	
CONC	CONCRETE		5	
COORL	COORDINATE	5 SAN	SOUTH SANITARY	
CR C/O	COUNTY ROAD CLEANOUT	SHWE	SEASONAL HIGH WATER ELEVATION	
., .,		5L	SLOPE	
DBH	DIAMETER AT EREAST NEIGHT	SP SR	SUPERPAVE STATE ROAD	
DE	DRAINAGE EASEMENT	SS	SANITARY SEWER	
DEG	DEGREE	ST	STORM	
DIA DIP	DIAMETER DUCTILE IRON PIPE	STA	STATION STANDARD	
DWG	DRAWING			
		TCE	TEMPORARY CONSTRUCTION EASEMENT	
e	E RATE OF ELEVATION	TEMP	TEMPORARY	
ε	EAST	TOB	TOP OF BANK	
EA EL	EACH ELEVATION	TV TW	TELEVISION TOP OF WALL	
ELEV	FLEVATION	TYP	TYPICAL	
EOP	EDGE OF PAVEMENT			
EOR ERCP	ENGINEER OF RECORD ELLIPTICAL REINFORCED CONCRETE PIPE	USF	U UNITED STATES FOUNDRY	
ESMT	EASEMENT	USGS	UNITED STATES GEOLOGICAL SURVEY	
EVCS	END VERTICAL CURVE STATION	UTIL	UTILITY	
EVCE EX	END VERTICAL CURVE ELEVATION EXISTING		V	
		V	VERTICAL	
FAC	F FLORIDA ADMINISTRATIVE CODE	VC VCP	VERTICAL CURVE VITRIFIED CLAY PIPE	
FBR	FLORIDA BEARING RATIO	-		
FC	FRICTION COURSE	w	W	
FDEP	FLORIDA DEPARTMENT OF ENVIRONMENTAL PROTECTION	w	WEST WAYER	
FDOT	FLORIDA DEPARTMENT OF TRANSPORTATION	W/	WITH	
FFE FH	FINE HYDRANT	WW	WATER MAIN WASTEWATER	
FHWA	RONDA HICHWAY ADMINISTRATION	WWF	WELDED WILL FABRIC	
FIG	FIGURE			
FM FOC	FORCE MAIN FACE OF CURB			
FS.	FLORIDA STATUTES			
FT	FEET			
	G			
GALV	GALVANIZED			
GM GV	GAS MAIN GATE VALVE			
uv				
	Н			
HDPE HP	HIGH DENSITY POLYETHYLENE HIGH POINT			
10	I I I I I I I I I I I I I I I I I I I			
ID	IDENTIFICATION INVERT			
INV EL	INVERT ELEVATION			
IP.	IRON PIPE			
	K			
К	VERTICAL CURVE RATE OF CHANGE			
	t.			
L	LENGTH			
LA	LANDSCAPE ARCHITECT			
LBR LDR	LIMEROCK BEARING RATIO			
LF	LINEAR FEET			
LP	LOW POINT			
LT	LEFT			
	M			
MAX	MAKIMUM			
ME MH	MATCH EXISTING MANHOLE			
MIN	MINIMUM			
****	MISCELLANEOUS			
MISC MUTCD	MANUAL ON UNIFORM TRAFFIC CONTROL			

SITE INFORMATION EX. PROPERTY LINE LANDSCAPE BUFFER LINE - WETLAND LIMITS LINE - WETLAND SETRACK LINE CENTER LINE - FASEMENT LINE - RIGHT-OF-WAY LINE SE SE SET FENCE LINE TREE BARRICADE LINE EX. STRUCTURE OR BUILDING PROPOSED BUILDING PROPOSED CONCRETE PAVEMENT PROPOSED DETECTABLE WARNING SURFACE H EX, ELEVATION CONTOUR PROPOSED CONTOUR EX. SPOT ELEVATION 9.1.2.1 PROPOSED SPOT ELEVATION DIRECTION OF SURFACE DRAINAGE FLOW PROPOSED SWALE LINE X EX. FENCE O PROPOSED FENCE EX. TREE (SIZE & TYPE) 1234 CEL TREE (TREE ID) EX. TREE TO BE REMOVED (SIZE & TYPE) EX. TREE TO BE REMOVED (TREE ID) PROJECT BENCHMARK

STORMWATER WASTEWATER THE PROPOSED STORMWATER STRUCTURES DEPICTED BELOW ARE DRAWN PER FE SPECIFICATIONS AND TO SCALE WHEN SHOWN ON THE PLAN SHEETS. ____ W ____ NV ____ EX. CRAVITY WASTEWATER MAIN P-WW PROPOSED GRAVITY WASTEWATER MAIN (PIPE LENGTHS ARE
FROM NE LOCATION OF A STRUCTURE TO NELOCATION OF
A STRUCTURE) ST --- ST EX. GRAVITY STORMWATER MAIN FN EX. WASTEWATER FORCE MAIN ST. EX. STORMWATER MANHOLE P-FM PROPOSED WASTEWATER FORCE MAIN TOP/RIM ELEV. LOCATION O PROPOSED 45" DIA. STORMWATER MANHOLE PER FDOT NOEX. NO. 2001 AND 201 TOP/GRATE ELEV. LOCATION -PROPOSED CIRCULAR AREA DRAIN S EX. WASTEWATER CLEANOUT PROPOSED SQUARE AREA DRAIN PROPOSED WASTEWATER CLEANOUT PROPOSED WASTEWATER GREASE TRAP MH# PROPOSED WASTEWATER MANHOLE ID TOP ELEV. COCATION PROPOSED TYPE & CURB INLET TOP FER FOOT INDEX NO 22.5" BEND W/ MECHANICALLY RESTRAINED JOINTS (WW FORCE MAIN) PROPOSED TYPE 3 CURS MALET TOP PER FOOT INDEX NO. 210 ISEE PLANS FOR BOTTOM SPECIFICATIONS 45" BEND W/ MECHANICALLY RESTRAINED
JOINTS (WW FORCE MAIN) TOP ELEV. LOCATION T₄ 90° BEND W/ MECHANICALLY RESTRAINED JOINTS (WW FORCE MAIN) WYE W/ MECHANICALLY RESTRAINED
JOINTS (WW FORCE MAIN) TOP DEV. LOCATION M EX. PLUG VALVE AND BOX (WW FORCE MAIN) TOP ELEY, LOCATION PROPOSED TYPE 6 CURB INLET FOR PER FOOT INDEX NO. 211 PROPOSED PLUG VALVE AND BOX (WW FORCE MAIN) ⇒ EX. AIR RELEASE VALVE (WW FORCE MAIN) ○ PROPOSED AIR RELEASE VALVE (WW FORCE MAIN) MISCELLANEOUS UTILITIES PROPOSED AT&T LINE BC BC EX. BURIED CABLE LINE ---- PROPOSED BURIED CABLE LINE BTEL EX. BURIED TELEPHONE LINE P-TEL PROPOSED TELEPHONE LINE CATY EX. CABLE TELEVISION LINE P-TV ----- PROPOSED CABLE/TELEVISION LINE - 10 - 10 - DE DRIP OFFIC UNE - USTO. -- EX UNDERCROUND TELEPHONE LINE I. EX. TELEPHONE PEDESTAL CHW CHW EX. CHILLED WATER MAIN TOP/GRATE ELEV LOCATION P-CHW PROPOSED CHILLED WATER MAIN - INE ----- EX FIRE MAIN P-FIRE PROPOSED FIRE MAIN INV. ELEV. LOCATION -MOPOSED FLARED END SECTION PER FDOT INDEX NO. 270 P-IRR ----- PROPOSED IRRIGATION LINE STEAN EX. STEAM LINE PIPE INV. ELEV. LOCATION P-STEAM PROPOSED STEAM LINE PROPOSED CROSS DRAIN MITERED END SECTION PER FDOT P-CLAY PROPOSED CLAY ELECTRIC LINE PIPE INV. ELEV. LOCATION PROPOSED SIDE DRAIN MITERED END SECTION PER FDOT INDEX NO. 273 (SEE PLANS FOR SIZE) P-E PROPOSED ELECTRIC LINE (\$\overline{3}\overline{0}\) PROPOSED STORMWATER STRUCTURE ID TAG P-LIGHT PROPOSED PRIVATE LIGHTING LINE POTABLE AND RECLAIMED WATER C EX. LIGHT € EX. UTILITY POLE W EX. POTABLE WATER MAIN EX, UTILITY POLE PROPOSED POTABLE WATER MAIN O EX. WOOD POWER POLE - BCW - BCW - EX. RECLAIMED WATER MAIN -> EX. GUY ANCHOR P-RCW PROPOSED RECLAIMED WATER MAIN T PROPOSED TRANSFORMER 11.25 BEND W/ MECHANICALLY RESTRAINED JOINTS (POTABLE AND RCW)

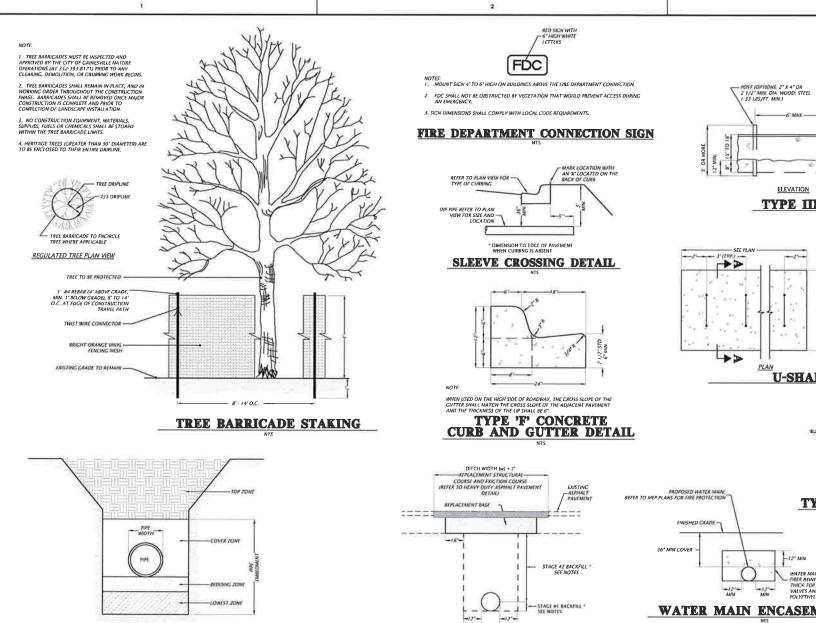
22.5 BEND W/ MECHANICALLY RESTRAINED JOINTS (POTABLE AND RCW) GAS GAS LINE P-GAS ---- PROPOSED CAS LINE 45 BEND W/ MECHANICALLY RESTRAINED JOINTS (POTABLE AND RCW) © EX. GAS MARKER G EX. GAS MARKER L₁ 90" BEND W/ MECHANICALLY RESTRAINED JOINTS (POTABLE AND RCW)

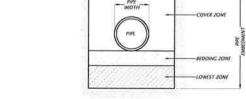
LT TEE (POTABLE AND RCW) CROSS (POTABLE AND RCW) OI BLOWOFF ASSEMBLY (POTABLE AND RCW) M REDUCER (POTABLE AND RCW) M EX. GATE VALVE AND BOX (POTABLE AND RCW) PROPOSED GATE VALVE AND BOX (POTABLE AND RCW) ⊕ EX. AIR RELEASE VALVE (POTABLE AND RCW) @ PROPOSED AIR RELEASE VALVE (POTABLE AND RCW) "C" EX. FIRE HYDRANT ASSEMBLY O PROPOSED FIRE HYDRANT ASSEMBLY I PROPOSED SAMPLE POINT EX. WATER METER (POTARI E AND ROW) PROPOSED POTABLE WATER METER PROPOSED POTABLE WATER BACK FLOW PREVENTER A PROPOSED RECLAIMED WATER METER T., THIS LEGEND IS ALL INCLUSIVE AND MAY INCLUDE ITEMS NOT A PART OF THIS PLAN SET. (W) EX. WATER WELL * EX, HOSE BIB (POTABLE AND RECLAIMED) 2. SYMBOLS SHOWN ON THIS SHEET ARE FOR ILLUSTRATIVE PURPOSES PROPOSED HOSE BIB (POTABLE AND RECLAIMED) ONLY. UNLESS NOTED OTHERWISE, SYMBOLS IN THESE PLANS MAY NOT BE REPRESENTATIVE OF SIZE. (1) PROPOSED FITTING ID TAG (POTABLE AND RECLAIMED)

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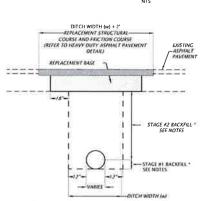




- 1. STORM PIPE BEDDING AND BACKFILL SHALL BE PER FDOT SPECIFCIATION 125 R AND 125 G
- Z SOIL/MATERIAL TYPES ARE AS DETERMINED PER AASHTO M145 SOIL CLASSIFICATIONS AND ASTM D3282.
- 4. THE LOWEST ZONE IS BACKFILLED FOR DEEP UNDERCUTS UP TO WITHIN FOUR (4) INCHES OF THE BOTTOM OF THE PIPE. BACKFILL IN THIS ZONE SHALL BE COARSE SAND, ON OTHER SUITABLE GRANULAR MATERIAL, OBTAINED FROM THE GRADING OFFERTATIONS ON THE PROJECT, OR A COMMIRCIAL MATERIAL (AS APPROXIDED BETTLE EMPRISED FRECORD) IF NO SUITABLE MATERIAL IS AVAILABLE. COMPACT THE SOIL TO APPROXIMATELY MATCH THE DENSITY OF THE SOIL IN WHICH THE TRENCH MAS CUT.
- THE BEDOING JONE IS ABOVE THE LOWEST ZONE AND USUALLY WILL BE THE BACKERL WHICH IS THE FOUR LO INCHES OF SOR BELOW THE BOTTOM OF THE PIEW, WHICH MOCK OR OTHER HAND MATERIAL HAS BEEN BERMOVED OR PIECE THE PIECE, THE BEDOING ZONE WILL BE THE TWILLY LESS HOUSED OF SOR BELOW THE BOTTOM OF THE PIECE THE BACKEL PIECE THE THE PIECE WAS THAN IN LIFTS NO GREATER THAN SIGN (IN INCHES COMPACTED THICKNESS IN INCHES TO SOME THE PIECE WAS THAN IN LIFTS NO GREATER THAN SIGN (IN INCHES COMPACTED THICKNESS IN INCHES TO SOME THE PIECE WAS THAN IN LIFTS NO GREATER THAN SIGN (IN INCHES COMPACTED THICKNESS IN INCHES TO SOME THE PIECE WAS THE PIEW WAS THE PIECE WAS THE PIEC

- 8. MINIMUM ACCEPTABLE COMPACTION FOR THE BEDDING, COVER, AND TOP ZONES IS 100% OF THE STANDARD PROCTOR MAXIMUM DENSITY AS DETERMINED BY AASHTO 1-99, METHOD C. FOR METAL OR PLASTIC PIPE, COMPACT THE BACKFILL TO A DENSITY OF AT LEAST 39% OF THE STANDARD PROCTOR AS DETERMINED AT ASSISTOT 3-99, METHOD C.
- 9 WHEN INSTALLING HOPE PIPE, BEDDING, BACKFILL, AND GENERAL INSTALLATION REQUIREMENTS SHALL COMPLY WITH ASTM 02321

STORM PIPE BEDDING AND BACKFILLING DETAIL



IN STAGE #2, CONSTRUCT COMPACTED FILL ALONG THE SIDES OF THE PIPE AND UP TO THE BOTTOM OF THE BASE, WITH THE UPPER 12' RECEIVING TYPE & STABILIZATION, IN LIEU OF TYPE & STABILIZATION, THE CONTRACTOM MAY CONSTRUCT USING OPTIONAL BASE GROUP 3.

NEW 8" LIMEROCK BASE SHALL BE COMPACTED TO NOT LESS THAN 98% OF MAX DENSITY AS
SPECIFIED BY THE FLORIDA DEPARTMENT OF TRANSFORTATION STANDARD SPECIFICATION 200 7.2. THE
WIDTH OF THE LIMEROCK BASE SHALL BE THE WIDTH OF THE PIPE TRENCH PLUS 18" ON BOTH SIDES SEE
DETIAL.

4. UNIESS OTHERWISE SPECIFIED, MATERIALS AND METHODS OF OPERATION REQUIRED TO INSTALL NEW AND REPLACEMENT PAYEMENT SHALL BE IN ACCORDANCE WITH THE LATEST APPLICABLE REQUIREMENTS OF THE FLORIDO BEPARTMENT OF TRANSPORTATION STANDARD SPECIFICATIONS FOR HOAD AND BRIDGE CONSTRUCTION.


5 PAVEMENT SHALL BE REMOVED TO NEATLY SAWED STRAIGHT EDGES.

THE TYPE AND THICKNESS OF THE NEW SURFACE MATERIAL SHALL BE CONSISTENT WITH THAT OF THE EXISTING SURFACE, BUT IN ALL CASES SHALL MEET THE MINIMUM STANDARDS ESTABLISHED BY THE PLANS AND SECRIFICATIONS.


8. PAVEMENT CUTS SHALL HAVE THE ASPHALT SURFACE REPLACED WITHIN 24 HOURS, WITH OPEN CUT RESTORATION PERFORMED IN ACCORDANCE WITH MOST CURRENT EDITION OF FOOT INDEX NO. 307 USING THE FLWARLE FILL OPTION.


9. THE CITY OF GAINESVILLE PUBLIC WORKS DEPARTMENT SHALL BE NOTIFIED BY CALLING 352-334-5070 PRIOR TO START OF EXCAVATION.

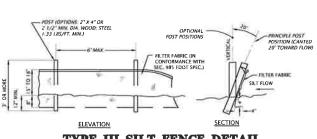
OPEN CUT AND REPAIR PAVEMENT DETAILS




TYPE III SILT FENCE DETAIL

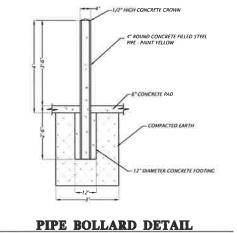

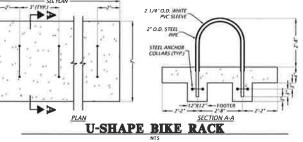


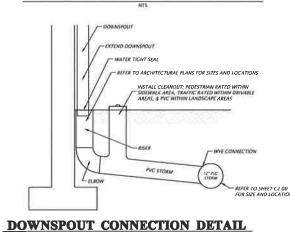

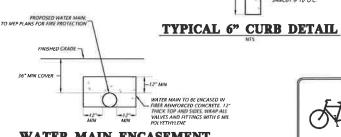


WATER MAIN ENCASEMENT



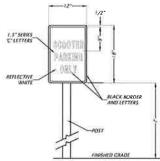

BICYCLE PARKING SIGN

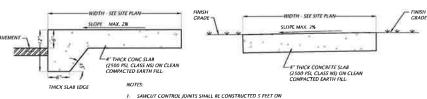SCOOTER PARKING SIGN DETAIL



ADJACENT TO PAVEMENT NOT ADJACENT TO PAVEMENT CONCRETE SIDEWALK DETAILS

FL PE No. 69101 CO.12

132 NW 78th Drive Galnesville, Florida 22607 (382) 331-1976 (382) 331-9478 WWATH-fracom est 1966 FLORIDA OA-5075

WZBYY SCALE
MAR IS ONE BACH ON
GROWAL DRAWING

MATTER BACH IS ONE
THES SELET, ADALIST
SCALES ACCORDINGLY

SAWCUT CONTROL JOINTS SHALL BE CONSTRUCTED 5 FEET ON CENTER

ALTA/ACSM LAND TITLE SURVEY

LOCATED IN SECTION 5, TOWNSHIP 10 SOUTH, RANGE 20 EAST, CITY OF GAINESVILLE, ALACHUA COUNTY, FLORIDA


ZONING RESTRICTIONS: UMU-2

	NON RESIDENTIAL & VERTICALLY MIXED USI; BUILDINGS	SINGLE-FAMILY DWELLINGS	MUTI-FAMILY DWELLINGS, TWO-FAMILY DWELLINGS & DOWNLOISES
(minimum)	90 feet	90 feet	90 feet
entampe Side (Minimum)	O feet, or 25 feet when abutting property designated single-family or residential low-density on the future land use map	3 feet except that, where adjoining lots are developed at the same time under single ownership, one side of each lot may have no yard setback if the setback for the adjoining yard is at least 10 feet	7.5 feet, or 25 feet when abutting property designated single-family or residential low-density on the luture land use map
Repr (minimum)	O feet, or 25 feet when abotting property designated single family or residential low-density on the future land use map	10 fc et	5 feet, or 25 feet when abutting property designated single family or residential low density on the future land use map.
Last cuvera (n (maximum)	N/A	N/A	80%
Building Interliget	70% annumum	N/A	70% eventsum
Demity (min.mum32	Within University Heights and the Archer Triangle, N/A	N/A	within University Heights and the Archer Triangle, 10
	Within the Urban Village, to be considered mixed use, a restidential development must include a minimum of 10,000 square feet of nonresidential uses; and a nonresidential development must contain a minimum of 3 residential units.		Within the Urban Village, 20 du/acre for new, single use multi family occurs, 10 du au- developments and additions to existing developments
Density [maximum]	Within University Heights and the Archer Triangle 100 du/acre, or up to 125 du/acre by special use	N/A	Wilhin University Heights and the Archer Triangle, 100 du/acre, or up to 125 du/acre by special use permit
	When the Urban Village, too did also by night, the sub- tion of the sub-sub-sub-sub-sub-sub-sub-sub-sub-sub-		Wittin the Orban Vivage, 100 and 100 etc. 100 et
Height and	Non single family by	uidings shall have a minimi	om height of 24 feet.
	maximum of eight stories is Within the Urban Village, only structured and/or or accessible surface parking sy for	n maximum of eight stories i street parking is provided paces for multi family devel progressemental developmen	is permitted by right when (except for handicapped opment and loading spaces nt)
	Within the Power District, a fine when located adjacent		ted in Figure 3.0. Is permitted at the build to order 34 depicted in Figure

SURVEYOR'S NOTES:

- 1. BEARINGS SHOWN HEREON ARE BASED ON FLORIDA STATE PLANE NORTH GRID NAD 83(1988), TIED TO THE ALACHUA COUNTY DENSIFICATION AND CONTROL NETWORK.
- 2. THE SURVEYOR HAS NO KNOWLEDGE OF UNDERGROUND FOUNDATIONS WHICH MAY ENCROACH
- INSTRUMENTS OF RECORD REFLECTING EASEMENTS, RICHTS-OF-WAY, AND OR OWNERSHIP WERE FURNISHED TO THE SURVEYOR BY FIRST AMERICAN TITLE INSURANCE COMPANY, FILE NO.: 2037-3133580, DAIED SEPTEMBER 22, 2015, A SEARCH OF THE PUBLIC RECORDS HAS NOT BEEN DONE BY THE SURVEYOR.
- 4. FENCES, SYMBOLS, MONUMENTATION AND UTILITIES SHOWN HEREON MAY BE EXAGGERATED FOR PICTORIAL PURPOSES ONLY AND MAY NOT BE SHOWN TO SCALE.
- 5: TREE SIZES SHOWN HEREON ARE IN DIAMETER (MEASURED AT CHEST HEIGHT).
- 6. INFORMATION FROM FEDERAL EMERGENCY MANAGEMENT AGENCY, (F.E.M.A.) FLOOD INSURANCE RATE MAP(S), SHOWN ON THIS MAP WAS CURRENT AS OF THE REFERENCED DATE, MAP REVISIONS AND AMENDMENTS ARE PERIODICALLY MADE BY LETTER AND MAY NOT BE REFLECTED ON THE MOST CURRENT MAP.
- 7. IN THE OPINION OF THIS SURVEYOR, THE PERIMETER LINES AS SHOWN HEREON REPRESENT THE LOCATION OF THE BOUNDARY LINES OF THE SUBJECT PARCEL IN RELATION TO THE DESCRIPTION OF RECORD AND THOSE EXISTING LAND CONNERS FOUND TO BE ACCEPTABLE BY THIS SURVEYOR.
- B. THE VERTICAL INFORMATION SHOWN HEREON IS BASED ON NAVD 1988 DATUM PROJECTED FROM A U.S. COAST & GEODETIC SUPREY BENCHMARK #42 (4*x* CONCRETE MINIMENT WITH BRASS DISK) WITH A PURILSHED ELEVATION OF 156-010 (NAAVO. 1988 DATUM) LOCATED AT THE NORTHWEST CORNER OF S.W. 2nd AVENUE AND S.W. 8th STREET AS SKOWN HEREON.
- 9. ADDITIONAL POINTS MAY BE FOUND BY TURNING ON THE SV-NODE* LAYERS IN THE SUPPLIED DIGITAL FILE.
- 10. LOCATIONS OF UNDERGROUND UTILITIES SHOWN HEREON ARE BASED ON WSIBLE SURFACE EVIDENCE THEREOF IN CONJUNCTION WITH UTILITY MAPS, AND FIELD LOCATED PAINT MARKINGS BY GAINESWILLE REGIONAL UTILITIES. THE RELITIVE ACCURACY OF THE UTILITIES LOCATED BASED ON MSIBLE PAINT MARKINGS IS ±24 INCHES OF EITHER SIDE OF THE UTILITY. THE EXCAVATION OF UNDERGROUND UTILITIES HAS NOT BEEN PERFORMED BY THIS SURVEYOR.

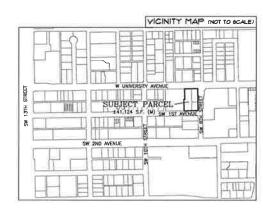- 13 THERE ARE NO STRIPED PARKING SPACES ON THE SUBJECT PROPERTY.
- 14. THERE IS NO OBSERVED EVIDENCE OF CURRENT EARTH MOVING WORK, BUILDING CONSTRUCTION OR BUILDING ADDITIONS...
- 15. THERE ARE NO PROPOSED CHANGES IN STREET RIGHT OF WAY LINES AND THERE IS NO OBSERVED EVIDENCE OF RECENT STREET OR SIDEWALK CONSTRUCTION OR REPAIRS.
- 16 THERE IS NO OBSERVED EVIDENCE OF SITE USE AS A CEMETERY, SOLID WASTE DUMP, SUMP OR SANITARY LANDFILL.



FLOOD ZONE:

LEGEND:

ID = IDENTIFICATION
B/W = RIGHT OF WAY
ORB = OFFICUL RECORDS BOOK
PG = PAGE
SF. = SQUARE FEET
(M) = DATA BASED ON FIELD MEASUREMENTS

- (P) = DATA BASED ON PLAT OF RECORD (CP) = CALCULATED DATA BASED ON PLAT OF RECORD

- = BENCHMARK
 = FOUND DRILL HOLE
 = FOUND REBAR & CAP AS NOTED

DESCRIPTION: (PER FURNISHED TITLE COMMITMENT)

PARCEL 1:
THE WEST 3.5 FEET OF LOT 2. THE EAST 45 FEET OF LOT 3, ALL
OF LOT 14, AND THE WEST 35 FEET OF LOT 15, INCLUDING THE
APPLIED OF THE PARCEL SHOWN OF THE PUBLIC RECORDS OF ALACHUA COUNTY, FLORIDA.
77 OF THE PUBLIC RECORDS OF ALACHUA COUNTY, FLORIDA.

PARCEL 2:
LOT 15 AND THE EAST 20 FEET OF LOT 2 AND THE NORTH 24
FEET OF THE EAST 20 FEET OF LOT 15 AND THE NORTH 24
FEET OF THE EAST 20 FEET OF LOT 15 AND THE NORTH 24 FEET
OF LOT 16, BLOCK 1, OF UNIVERSITY PLACE, AS FEE


PARCEL 3:
LOT 15 AND ALL OF LOT 16, BLOCK 1, OF UNIVERSITY PLACE, AS PER PLAT THEREOF RECORDED INPLAT BOOK A, PAGE 77 OF THE PUBLIC RECORDS OF ALACHUA COUNTY, FLORIDA, LESS AND EXCEPT THE NORTH 24 FEET OF SAID LOT 18 AND LESS AND EXCEPT THE NORTH 24 FEET OF SAID LOT 18 AND LESS AND EXCEPT THE MEST 35 FEET OF SAID LOT 15 AND LESS AND EXCEPT THE WEST 35 FEET OF SAID LOT 15


SCHEDULE B-II EXCEPTION: (PER FURNISHED TITLE COMMITMENT)

ITEM 9: THE SUBJECT PARCEL IS SUBJECT TO ALL MATTERS APPEARING ON THE PLAT RECORDED IN PLAT BOOK A, PAGE(S) 77, INCLUDING, BUT NOT LIMITED TO, ANY BUILDING SETBACK LURES AND/OR EASEMENTS LYING WITHIN LOT(S) DESCRIBED IN SCHEDULE "A",

TO THE BENOIT GROUP: THE LAND, LLC; AND FIRST AMERICAN TITLE INSURANCE COMPANY; DEAN, MEAD, EGERTON, BLOODWORTH CAPOUANO & BOZARTH, P_iA_i :

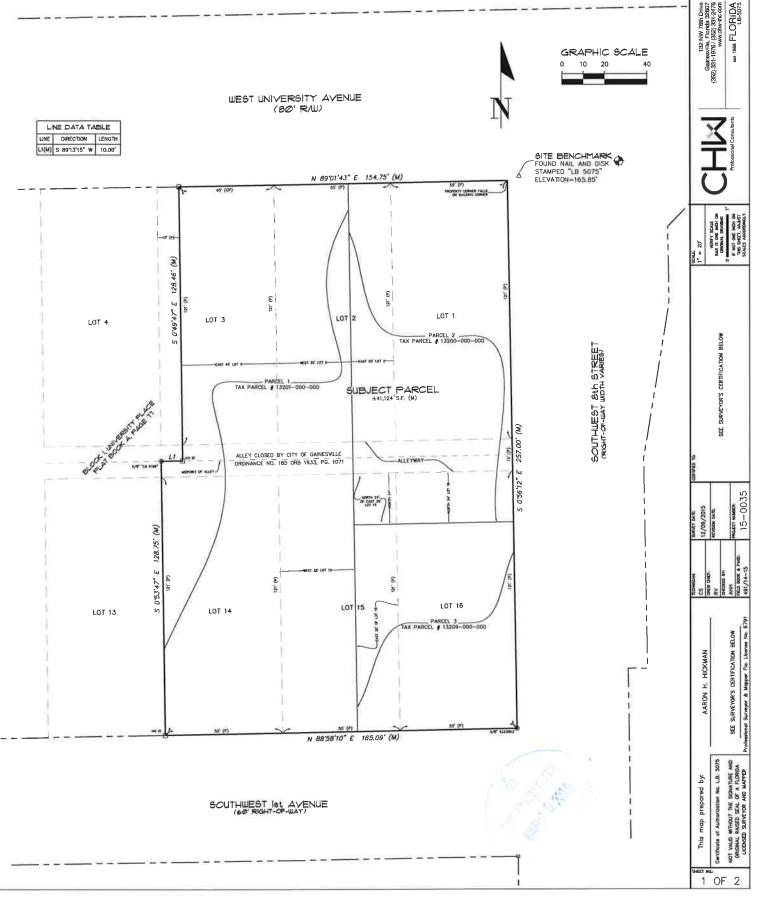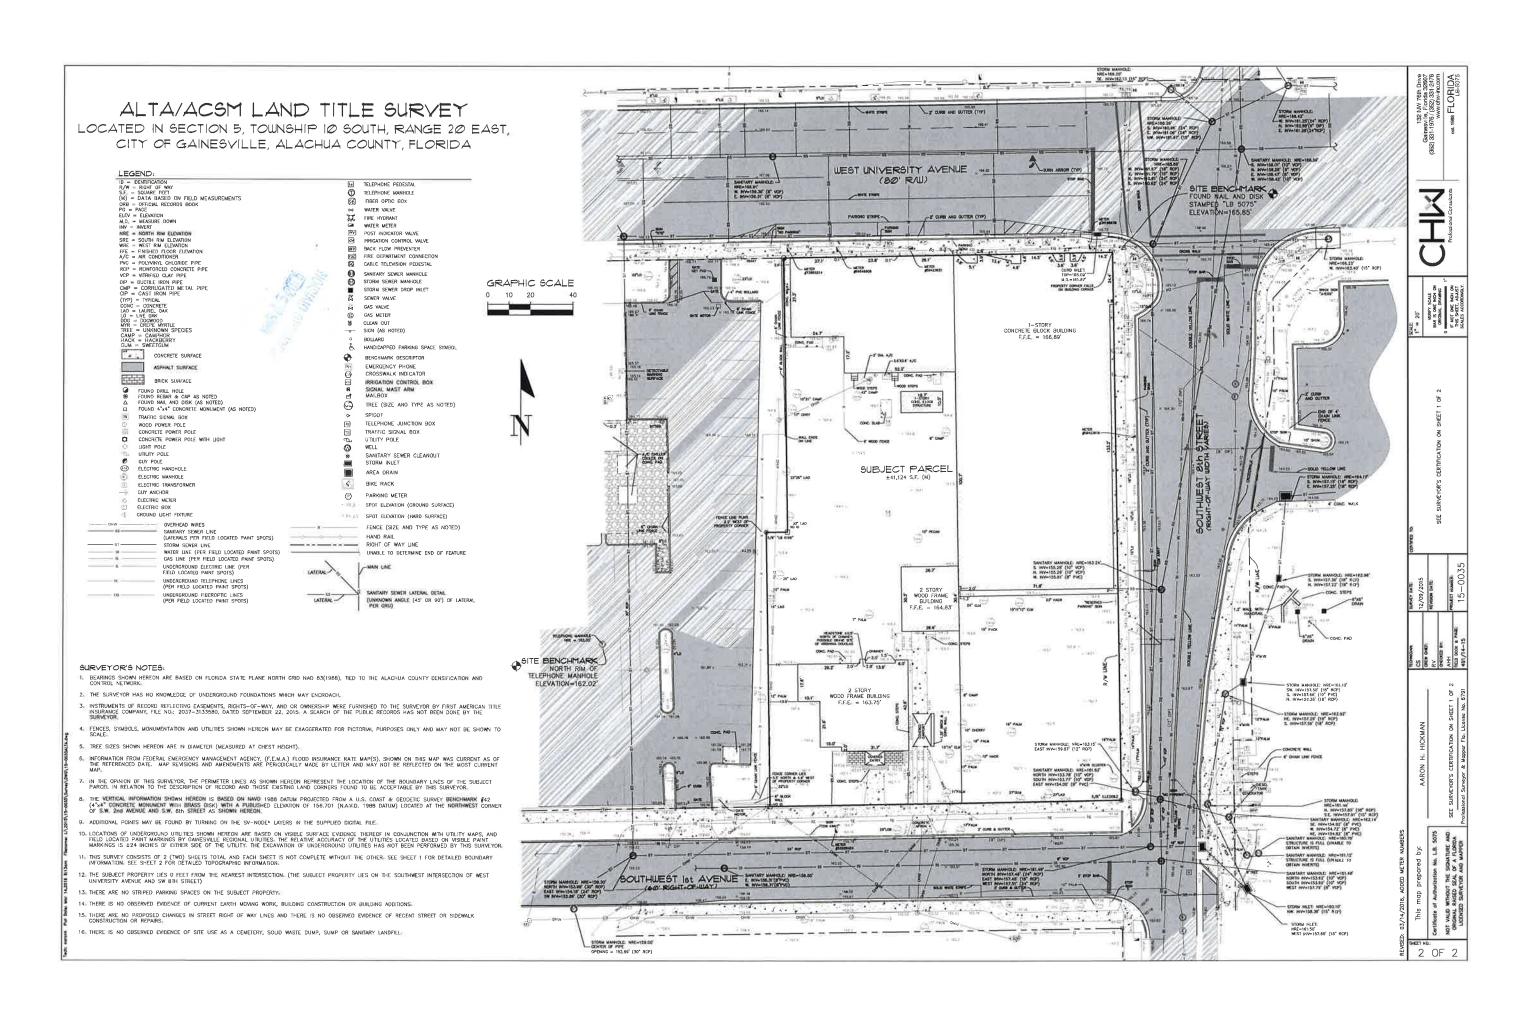THIS IS TO CERTIFY THAT THIS MAP OR PLAT AND THE SURVEY ON WHICH IT IS BASED WERE MADE IN ACCURDANCE WITH THE 2011 MINIMUM STANDARD DETAIL REQUIREMENTS FOR ALTA/ACSW HAND TITLE SURVEYS, JOINTLY ESTABLISHED AND ADOPTED BY ALTA AND NSPS, AND INCLUDES ITEMS 1, 2, 3, 4, 5, 6(b), 7(a), 7(b), 18, 9, 10(a), 11(b), 11(b), 13, 14, 16, 17, 18, 20(a) AND 21 OF TABLE A THEREOF. THE FIELD WORK WAS COMPLETED ON DECEMBER 09, 2015.





THIS DOCUMENT WAS PREPARED IN ORDER TO ILLUSTRATE COMPLIANCE WITH CHAPTER 62 621,300 (4) OF THE FLORIDA ADMINISTRATIVE CODE, WHICH PERTAINS TO THE GENERIC PERMIT FOR STORMMATER DISCHARGE FROM LARGE AND SMALL CONSTRUCTION ACTURIES. THE ADMINISTRATIVE CODE GRANTS THE FLORIDA DEPARTMENT OF ENVIRONMENTAL PROTECTION FORE) THE AUTHORITY OR GEGLATE FORM SOURCE DISCHARGE OF STORMMATER ROM CONSTRUCTION STEES. THIS DOCUMENT ESTABLISHES A STORMMATER POLUTION REVENTION FLAR FOR THE STEE AND IS DRICANIZED TO CORRESPOND TO PART V OF FUEP DOCUMENT NO. 62 62 I 3004(4), FUEP FORM 62 627, 304(4) IS TO BE SUBMITTED IN CONJUNCTION WITH THIS DOCUMENT.

II. SITE DESCRIPTION

ALACHUA COUNTY, FLORIDA SECTION S, TOWNSHIP 10 SOUTH, RANGE 20 EAST 13201-000 000, 13200 000 000, 13209 000 000 805-819 WEST UNIVERSITY AVE. COUNTY: SECTION, TOWNSHIP, RANGE: COUNTY PARCEL NO STREET ADDRESS: ±0.94 ACRES
SEE COVER SHEET OF CONSTRUCTION DRAWINGS

A. NATURE OF CONSTRUCTION ACTIVITY

THE PROPOSED DEVELOPMENT IS A MIXED USE MULTI-STORY BUILDING WITH ±110 DWELLING UNITS, ±4,000 SF OF NON-RESIDENTIAL GROUND LEVEL RETAIL, ASSOCIATED HARDSCAPE, AND UTILIES, SERVED BY AN INTERNAL PARKING STRUCTURE AND STORM WATER FACILITIES. THE PROJECT SITE IS LOCATED AT WEST UNIVERSITY AVE. AND SW 81TH STREET, CAMESVULE FLORIOD. THE PROJECT SITE TOTAL RABE IS APPROXIMATELY 0 94 ACRES HAD SERVICED STRUCTURE.

B. SEQUENCE OF MAJOR SOIL DISTURBING ACTIVITIES

- ASSICTATED STORMMATER MANAGEMENT FACILITIES.

 THE PERMANENT ROADWAY/ORINEWAY SUBGRADE SHALL BE COMPACTED, A LIMEROCK BASE SHALL BE ESTABLISHED, AND THEN FOLLOWED BY AN OVERLAY OF
- ASPHALT.

 10. UPON SCHIPECANT COMPLETION OF CONSTRUCTION, THE STORAWATER PIPING SYSTEM SHALL BE FLUSHED OUT TO REMOVE ACCUMULATED DEBRS AND SEDIMENT.

 11. UPON COMPLETION OF THE DEBRS AND SEDIMENT REMOVAL FROM THE STORAWATER PIPING SYSTEM, THE PROPOSED STORAWATER MANAGEMENT FACILITYS)

 SHALL BE FINE GRADED AND BE EXCALATED A MINIMIMA OF THESE FEET BELOW THE OSEING BOTTOM BEVALVED AND REPLACED WITH HILL HAWING A MINIMIM
 PERMEABILITY BATE OF 20 FEET/DAY WITH A MANIMIMIN OF ION SOIL, FINES PASSING THE NO. 200 SIEVE. THE BOTTOM SHALL BE SCARIFED AND STABULZED
 ACCORDING TO THISE FRAMS. ONCE COMPLETEE NO PHERY MACHINERY SHALL BE ALLOWED WITHIN THE STORMAND AMAGEMENT FACILITYS).

 12. ALL REMAINING DISTINEED AREAS WITHIN THE CONSTRUCTION AREA SHALL BE COMPLETE! CRASSED AND/OR LANDSCAPED ACCORDING TO THESE PLANS. TURE
 SET OF THE PROPERTY OF THE PROPERTY PROPERTY OF REMOVED OF SILT PRICEMED AND ASSOCIATION OF SILT PRICING AND
 ATHLE REPRISEDY CONTROL OF SILT PRICEMED AND ASSOCIATION OF SILT PRICEMED AND ASSOCIATION.

C. SITE DEVELOPMENT DATA:

TOTAL IMPERVIOUS AREA (AS SHOWN IN CONSTRUCTION DRAWINGS): TOTAL RETENTION VOLUME TOTAL OPEN AREA

D. SOIL CONDITIONS AND STORMWATER QUALITY

THE NRCS DATA FOR THE SITE REVEALS THAT THE SITE SOILS ARE COMPRISED OF KANAPAHA SAND AND URBAN LAND. GSE, INC., CONDUCTED A GEOTECHNICAL EXPLORATION OF THE PROPOSED STORMWITTER MANAGEMENT FACILITY(S) LOCATION IN APRIL OF 2015. THE INVESTIGATION REVEALED THAT THE PROJECT SITES SURFACE SOILS HAVE THE FOLDOWING CHARACTERISTICS:

DEPTH TO EFFECTIVE OR MOBILIZED AQUIFER DEPTH OF SEASONAL HIGH WATER TABLE: HORIZONTAL HYDRAULIC CONDUCTIVITY. UNSATURATED VERTICAL INFILTRATION: 28 FEET/DAY 18 FEET/DAY 20% SPECIFIC YIELD (FILLABLE POROSITY)

DESIGN PERCOLATION RATES FOR THE STORMWATER MANAGEMENT FACILITY(S) WERE DETERMINED BASED ON LABORATORY PERMEABILITY TEST RESULTS FROM BORING SAMPLES TAKEN IN THE LOCATION OF THE STORMWATER MANAGEMENT FACILITY(S).

THE STORMWATER MAINGEMENT FACILITY(S) WAS DESIGNED TO PROVIDE RATE CONTROL OF THE STORMWATER RUNOFF RESULTING FROM THE POST-DEVELOPMENT SITE UNDER 100 YEAR CRITICAL STORM EVENT, AND THE STORM EVENT, AND MEAN ANNUAL STORM EVENT RAINFALL CONDITIONS. THE STORMWATER POLIUTION PREVENTION PLAN (CO.2.1) DEPOT THE POST-DEVELOPMENT WATERSHEDS) LIMITS AND THE TABLE BELOW SIMMARIZES EACH WATERSHED.

WATER QUALITY TREATMENT CREDITS ARE USED TO SATISFY WATER QUALITY TREATMENT VOILINE (WOTVO REQUIREMENTS OF 0.84 AC OF THE SITE. THE WQTV REQUIRED BY THE REMAINING 0.10 AC OF SITE IS PROVIDED IN THE STORMWATER MANAGEMENT FACILITY.

WATERSHED ID	POST DEVELOPMENT AREA (ACRES)	POST DEVELOPMENT RUNOFF FACTOR (CN)	POST DEVELOPMENT IMPERVIOUS AREA (ACRES)	STORMWATER MANAGEMENT FACILITY TYPE	FACILITY DETENTION CAPACITY (ACRE-FEET)	I 00 YEAR FLOOD ELEVATION (FT)
1	0.94	89	0.80	DRY RETENTION	0.21	165,53

E. SITE MAP

PLEASE SEE THE STORMWATER POLLUTION PREVENTION PLAN (CO. 21) FOR DETAILS.

F. STORMWATER OUTFALL LOCATION AND RECEIVING WATER BODY

FACILITY IS A PARTIALLY ABOVE GROWND, PARTIALLY UNDERGROWND DRY RETENTION SYSTEM. THE SITE OSCINARCES TO THE TURNELIN CREEK DRAWAGE

III. CONTROLS TO REDUCE POLLUTION

AS DITUNED IN THE ST. ICHMS NUSE WITE MANAGEMENT DISTRICT ISJAMED PEDMET, ALL CONSTRUCTION ATTIVITIES SHALL BE CONDUCTED IN A MANNER AS TO NOT MODIFIED THE THROUGHOUT FOR THROUGH AND MANNER ALL PROSON AND SENDENT CONTROL MASSIESS REQUIRED TO BETAIN SEDIMENT ON STIFE. F. STE CONDITIONS ARE SIGHT THAT ADDITIONAL CONTROL DISTRICT MANAGEMENT PRACTICES. THESE MASSIESS PRECIFIED IN THE REGISION AND SEDIMENTATION CONTROL PLAN. THEN THE CONTRACTOR SHALL IMPRIENT ADDITIONAL BEST MANAGEMENT PRACTICES. THESE MASSIESS MUST BE INSPECTED AND MAINTAINED THROUGHOUT THE CONSTRUCTION PHASE AND UNTIL AS DIRECTED BY THESE FLANS. THE STORMMATER POLLUTION PREVENTION PLAN (CO.2.1) AND SECTION IN BECOME PROVIDE DEFINES ON THE STORMMATER POLLUTION PREVENTION.

IV. EROSION AND SEDIMENT CONTROLS

A. STABILIZATION PRACTICES

EXISTING TREES AND NATURAL VEGETATION TO REMAIN ON-SITE SHALL BE PROTECTED BY TREE BARBICADE FENCING AS DEPICTED ON THE STORMWATER POLLUTION PREVENTION PLAN (CO.2.1). TYPE III SILT FENCING SHALL PROTECT ALL DRAINGES STRUCTURES AND SHALL BUFFER RARSA WITH POTENTIAL TO CONTRIBUTE OFF-SITE RIMOFF AND AS SEPCERICALLY DEPICTED ON THE STORMWATER POLLUTION PREVENTION PLAN (CO.2.1). STRUCTURES AND SHALL ENTITATED FOR EROSION AND STOMEST CONTROL ON DISTURBED AREAS AS SOON ESPECIFICALLY BUT IN NO CASE MORE THAN 7 DAYS, IN PORTIONS OF THE SITE WHERE CONSTRUCTION HAS TEMPORARILY OF REMAINSHIPLY CASED. AS SYNCHOLD IN SECTION IN A BROVE, UNDO CONFIDENCION, ALL THAT STANDAMM SECREMANT FACILITIES SHALL BE SCRAPE OLEAN OF ACCUMULATED SECTION HAS THE COMPLETION OF CONSTRUCTION. ALL THAT STANDAMM SECREMANT FACILITIES SHALL BE SCRAPE OLEAN OF ACCUMULATED SECTIONS AND STANDAMM SECREMANT SECRITIES.

B. STRUCTURE PRACTICES

AS DEPICTED IN THE STORMWATER POLLUTION PREVENTION FLAN (CO.21), A STORMWATER MANAGEMENT SYSTEM WILL BE CONSTRUCTED AND WILL BE COMPRISED OF A UNDERGROUND/ABOVE GROUND DIRNE CONSTRUCTION, TYPE III SILT FERENCE WILL BE STALLED IN THE LOCATIONS SHOWN ON THE FLANS. ALL EDSTINE AND PROPOSED STORM DIABNAS AND AMAGE SWALES SHAML BE PROTECTED ACCURDING TO FOOT MODERNO. TO 20 OR FOR DEFINIS PRODUCED ON SHEET CO.21 UNTIL CONSTRUCTION IS COMMETTE. THE STORM PIPE CONVEYANCE SYSTEM SHALL BE PROTECTED BE FULLSHED DIT OR REMOVE ALL ECCHINALIZED DEPICES AND SECURITY L'ONE TOWN OF CONSTRUCTION.

C. DRAINAGE LOCATIONS THAT SERVE AREAS WITH LESS THAN 10 DISTURBED ACRES

AS SPECIFIED IN THE 'SEQUENCE OF MAJOR SOUL DISTRIBUTION CATEFURING ACTIVITIES,' THE SMFG) WHILE ONSTRUCTOR PRIOR TO CLEARING AND GRUBBING OUTSIDE OF THE SMFG) AREAS AND CONSTRUCTOR OF THE PERMANENT PAVED AREAS. THE TOTAL CONTRIBUTING DAMPAGE AREA TO THE STORMMATER MANAGEMENT SYSTEM IS APPROXIMATELY AS A PROXIMATE THE ASSISTANCE ON A PROSECULATION AREA. THEREFOR, NO ADDITIONAL SEDIMENT TAKE ASSISTANCE ON A STRUCTION AREA. THEREFOR NO ADDITIONAL PREVENTION PLAN (CC. 2.1), THE PROPOSED STORMMATER MANAGEMENT SYSTEM WILL BE ROSSION DURING CONSTRUCTION. AS SHOWN ON THE STORMMATER POLLUTION PREVENTION PLAN (CC. 2.1), THE PROPOSED STORMMATER MANAGEMENT SYSTEM WILL BE ROSSION DURING CONSTRUCTIONS. SILF FENCES OR EQUIVALENT SEDIMENT CONTROLS SHALL BY A STRUCTURE AND DOWNSOLF OF DURING MAD SHALL BY A STRUCTURE OF AND DOWNSOLF OWNSOLF SOUNDEST OF A STRUCTURE O

D. DRAINAGE LOCATIONS THAT SERVE AREAS WITH MORE THAN 10 DISTURBED ACRES

V. STORMWATER MANAGEMENT

A. BEST MANAGEMENT PRACTICES

IFTER CONSTRUCTION, THE STORMMATER MANAGEMENT SYSTEM SHALL BE MAINTAINED IN ACCORDANCE WITH THE SPECIFIED STORMMATER MAINTENANCE NOTES IN THE INCLUDED CONSTRUCTION DRAWMES AND/OR RESPECTIVE MAINTENANCE REPORTS. SPECIFICALLY, THE PROPOSED SWIFIS SHALL BE MOWER REGULARLY WITHE PECIFED AREAS, STORM PIPES AND STRUCTURES WILL BE INSPECTED SEMI-ANNUALLY AND CLEANED ANNUALLY, SMIFIS SIDE SLOPES SHALL BE MAINTAINED TO PREVENT ROSION, AND LANDSCAPING AND CRASS THAT PREVENTS EROSION STRALL BE MAINTAINED. ADDITIONALLY, REMEDIAL ACTIONS STALL BE TAKEN SHOULD THE SMIFIS

B. VEGETATED SWALES

WHEN VEGETATED SWALES ARE UTILIZED, SILT FENCING OR EQUIVALENT SEDIMENT CONTROLS SHALL BE INSTALLED AT ADEQUATE INTERVALS TO COLLECT SEDIMENT ALONG. THE SWALE. THE SEDIMENT SHALL BE REMOVED WHEN SEDIMENT REACHES ONE-THIRD OF THE HEIGHT OF THE SILT FENCING. SEE THE STORMWATER POLLUTION PREVENTION PRINT OCC2) IF OR PETRILS AND CLOSTORIS, SER REQUIRED.

C. VELOCITY DISSIPATION DEVICES AT DISCHARGE POINTS

WHEN DISCHARGE POINTS ARE NOT LOCATED UNDER WATER, RIP RAP PADS HAVE BEEN PROVIDED AT LOCATIONS WHERE NECESSARY DUE TO ANTICIPATED DISCHARGE VELOCITIES. PLEASE SEE THE CONSTRUCTION PLANS FOR DETAILS AND LOCATIONS, AS NEEDED.

VL CONTROLS FOR OTHER POTENTIAL POLLUTANTS

A. WASTE DISPOSAL

THE CONTRACTOR SHALL PROVIDE LITTER COLLECTION CONTAINERS WITHIN THE PROJECT BOUNDARIES DURING CONSTRUCTION. CONTRACTOR SHALL DISPOSE OF ALL UNSUITABLE MATERIALS AND CONSTRUCTION DEBRIS IN ACCORDANCE WITH ALL APPLICABLE LOCAL, STATE, AND FEDERAL REQUIREMENTS.

B. DUST CONTROL

TO PREVENT OFF-SITE VEHICULAR TRACKING OF SEDIMENTS AND DUST GENERATION, A STABILIZED CONSTRUCTION ENTRANCE SHALL BE ESTABLISHED BY THE SITE CONTRACTOR. PLEASE SEE THE STORMWATER POLLUTION PREVENTION PLAN (CO.21) FOR DETAILS AND LOCATION(S).

C. EXISTING VERSUS PROPOSED POTABLE AND SANTTARY SEWER SYSTEMS

THERE ARE PROPOSED SANITARY SEWER AND POTABLE WATER SYSTEMS LOCATED ON THE PROJECT SITE. EXTENSION AND UPCRADES ARE PROPOSED, IF TEMPORARY SANITARY SYSTEMS ARE UTILIZED DURING CONSTRUCTION, THE CONTRACTOR SHALL PROPERLY CONTROL AND DISCHARGE ANY SANITARY WASTE IN ACCORDANCE WITH ALL APPLICABLE LOCAL, STATE, AND EDEPEAR RECIULATIONS.

D. FERTILIZER & PESTICIDES

THE USE OF FERTILIZERS, HERBICIDES, AND PESTICIDES ON THE PROJECT SITE, WILL BE DIRECTED BY THE LANDSCAPE PLAN AND THE FDOT INDEX NO. 104, TO SUPPORT THE GROWTH OF THE PROPOSED VIGETATION. ESTABLISHING THIS VEGETATION WILL AID IN THE STABLIZATION OF THE PROJECT SITE AND REDUCE BROSION. APPLICATION BASES FOR THE FERTILIZERS, HERBICIDES, AND PESTICIDES SHALL BE IN ACCORDANCE WITH THE MANUFACTURER'S RECOMMENDATIONS TO GUARD AGAINST OVER-USE, WHICH CAN LEAD TO VIOLATIONS OF STATE WATER QUALITY STANDARDS.

E. TOXIC MATERIAL

THE CONSTRUCTION SITE WILL BE IN FULL COMPLIANCE WITH STATE AND FEDERAL REQUIREMENTS. IN ADDITION, THE SITE SHALL BE IN COMPLIANCE WITH THE MORE STRINGENT ALACHUA COUNTY HAZABOOUS MATERIALS MANAGEMENT CODE, WHICH ADDRESSES STORAGE AND USE OF TOXIC MATERIALS LESS IN VOLUME THAN THE STATE THRESHOLD BEQUIREMENT.

VIL APPROVED STATE AND LOCAL PLANS

THE CONSTRUCTION DRAWINGS FOR THE PROJECT WERE APPROVED AND PERMITTED BY THE FOLLOWING AGENCIES: - CAINESVILLE REGIONAL DITILITIES ST. JOHNS RIVER WATER MANAGEMENT DISTRICT

VIIL CONSTRUCTION ACTIVITY DISCHARGES

N ACCORDANCE WITH THIS PLAN, THERE ARE NO ANTICIPATED DISCHARGES OF STORMWATER ASSOCIATED WITH CONSTRUCTION ACTIVITIES.

IX. CHANGES TO THE POLLUTION PREVENTION PLAN

THIS STRAMATER POLLUTION PREMETION PLAN SHALL BE AMENDED TO REFLECT ANY APPLICABLE CHANGE IN A STATE, REGIONAL, OR LOCAL BERNIT FOR WHICH THE PRINTITE RECEIVES WRITTEN NOTICE. WHEN WRITTEN NOTICE IS RECEIVED, THE PRANTITE STALL PROVIDE A RECERTIFICATION OF THIS POLLUTION PREVENTION PLAN, WHICH HAS BEEN REVISED TO ADDRESS SUCH CHANGES, AMENDMENTS TO THE PARK SHALL BE PREPARED, DATE, AND KEPT AS ATTACHMENTS TO THE DRIGHNES.

X. ALTERNATIVE PERMIT REQUIREMENTS

NO ALTERNATIVE PERMIT REQUIREMENTS ARE REQUESTED

THE CONTRACTOR IS RESPONSIBLE FOR THE MAINTENANCE, INSPECTION SCHEDULE, AND REPAIRS OUTLINED IN THIS PLAN. MAINTENANCE SHALL CONTINUE THROUGHOUT THE PROJECT UNTIL WORK IS COMPLETE. THE CONTRACTOR IS RESPONSIBLE FOR REMOVING ALL TEMPORARY EROSION AND SEDIMENT CONTROL DEVICES AFTER CONSTRUCTION IS COMPLETE. IN ADDITION TO THE HIMSE MENTIONED IN THE PREVIOUS SECTIONS, THE CONTRACTOR SHALL INITIATE ANY REPAIRS WITHIN 24 HOURS OF BRING REPORTED. IN THE EVENT THAT THE SAMES DO NOT PERFORM MODERLY ON IF A SINKHOLE DEVELOYS, THE PROJECT ENGINEER SHALL BE NOTHERD TO ASSIST IN COORDINATING REMODERLY ACCUMULATED SEMENTS FOR SERVICE SERVICES WITHIN 24 HOURS OF BRING REPORT OF THE STATE OF THE STAT

XIL INSPECTIONS

THE CONTRACTOR SHALL INSPECT ALL POINTS OF POTENTIAL DISCHARGE FROM THE PROJECT SITE FOR ALL DISTURBED AREAS ON THE CONSTRUCTION SITE AT LEAST ONCE USER'S SEVEN CALIDOAR DAYS ARE UITIES. YE OF THE OFFICE OFFICE OF THE OFFICE OF THE OFFICE OF THE OFFICE OF THE OFFICE OFFICE OF THE OFFICE OFFICE OF THE OFFICE OFFICE OF THE OFFICE OFFICE OFFICE OF THE OFFICE O

A. DISTURBED AREAS

ALL DISTURBED AREAS AND AREAS USED FOR MATERIAL STORAGE SHALL BE INSPECTED FOR POLLUTANTS ENTERING THE STORMWATER SYSTEM. THE STORMWATER MANAGEMENT SYSTEM AND EROSION AND SEDMENT CONTROL MEASURES IDENTIFIED IN THE PLAN SHALL BE INSPECTED TO ENSURE THEY ARE OPERATING CORRECTLY. LOCATIONS WHERE VEHICLES ENTER AND EXTIT THE STRAILE BY INSPECTED FOR EVIDENCE OF OFF-STES SEDIMENT TRACKING.

B. MAINTENANCE PERFORMANCE

BASED ON THE RESULTS OF THE INSPECTION, ALL MAINTENANCE OPERATIONS NEEDED TO ASSURE PROPER COMPLIANCE WITH THIS PLAN SHALL BE DONE IN A TIMELY MANNER, BUT IN NO CASE LATER THAN 7 DAYS FOLLOWING THE INSPECTION.

C. REPORTING REQUIREMENTS

ALL INSPECTIONS SHALL BE RECORDED ON THE CONSTRUCTION INSPECTION FORM, A COPY OF WHICH IS PROVIDED ON THIS SHEET. THIS FORM IS CREATED TO SUMMARIZE THE SCOPE OF THE INSPECTION, THE NAMEIS) AND QUALIFICATION OF THE INSPECTIONS, THE DATE OF INSPECTION, RAINFALL DATA, DESCRIATIONS, THE ACTIONS TAKEN TO CORRECT INCENTED SO FOND COMPLIANCE WITH THE PROVISIONS OF THIS PLAN. IF NO MICIDENTS OF NOVEMENT AND THE ASSOCIATED PERMIT. REPORT SHALL CONTAIN A CERTIFICATION THAT THE FACULTY IS IN COMPLIANCE WITH THE STORMWATER POLLUTION PREVENTION PLAN AND THE ASSOCIATED PERMIT.

XIIL NON-STORMWATER DISCHARGES

IN ADDITION TO STORMWATER RUNOFF, THIS PLAN APPLIES TO RUNOFF FROM IRRIGATION OPERATIONS AND CONSTRUCTION PRACTICES. THIS PLAN DOES NOT PERTAIN TO DISCHMINGS FROM IRRE INCHING ACTIVITIES.

XIV. CONTRACTORS CERTIFICATION

THE CONTRACTORS OR SUB CONTRACTORS SHALL PHOTOCOPY AND COMPLETE THE FORM ON THIS PAGE. IT SHALL BE PROVIDED TO THE OWNER AND KEPT ON FILE PURSUANT TO SECTION XV REGARDING PROJECT RECORDS.

XV. RETENTION OF RECORDS

THE PERMITTEE SHALL RETAIN COPIES OF STORMWATER POLLUTION PREVENTION PLANS AND ALL REPORTS REQUIRED BY THIS PERMIT, AND RECORDS OF ALL DATA USED TO COMPLETE THE NOTICE OF INTENT TO BE COVERED BY THIS PERMIT, FOR A PERIOD OF AT LEAST THREE YEARS FROM THE DATE THAT THE SITE IS FINALLY STABILIZED.

THE PERMITTEE SHALL RETAIN A COPY OF THE STORMWATER POLLUTION PREVENTION PLAN AND ALL REPORTS, RECORDS, AND DOCUMENTATION REQUIRED BY THIS PERMIT AT THE CONSTRUCTION SITE, OR AN APPROPRIATE ALTERNATIVE LOCATION AS SPECIFIED IN THE NOTICE OF INTENT, FROM THE DATE OF PROJECT INITIATION TO THE DATE OF FINAL STABILIZATION.



XVI. NOTICE OF TERMINATION

NOTICE OF TERMINATION:

- IN WHERE A SITE HAS BEEN FINALLY STABILIZED AND ALL STORMWATER DISCHARGES AUTHORIZED BY THIS PERMIT ARE ELIMINATED, THE PERMITTEE SHALL SUBMIT A NOTICE OF TERMINATION (DEP FORM 62 62) 300(6), GINED IN ACCORDANCE WITH PART VILL OF DEP DOCUMENT NO. 62 62) 300(4)(a), WITHIN 14 DAYS OF FINAL STABILIZATION OF THIS TIPE OF TERMINATE COVERAGE UNDER THIS PERMIT.

 2. ELIMINATION OF STORMWATER DISCHARGES ASSOCIATED WITH CONSTRUCTION ACTIVITY MEANS THAT ALL DISTURBED SOLLS AT THIS TIPE HAVE BEEN FINALLY STABILIZED AND TEMPORATE TEMPO, OR THAT ALL STORMWATER DISCHARGES ASSOCIATED WITH CONSTRUCTION ACTIVITY FROM THE SITE THAT BE AUTHORIZED BY THIS GENERIC PERMIT HAVE OTHERWISE BEEN FINALLY STABILIZED.
- STOMMWATER DISCHARGE PASSOCIATED WITH CONTINUED AND ACTIVITIES OF THE EXISTING OPERATOR SHALL FILE AN N.O.T. IN ACCORDANCE WITH THIS PART WITHIN 14 DAYS OF RELINGIASHING CONTROL OF THE PROJECT TO A NEW OPERATOR.

THE PERMITTEE SHALL SUBMIT A NOTICE OF TERMINATION TO THE FOLLOWING ADDRESS

NPDES STORMWATER NOTICES CENTER, MS# 2510
FLORIDA DEPARTMENT OF ENVIRONMENTAL PROTECTION

2600 BLAIR STONE ROAD FALLAHASSEE, FLORIDA 32399-2400

PROJECTS THAT DISCHARGED STORMMATER ASSOCIATED WITH CONSTRUCTION ACTIVITY TO A MUNICIPAL SEPARATE STORM SEWER SYSTEM (MS4) SHALL SUBMIT A COPY OF THE M.O.T. TO THE OPERATOR OF THE MS4.

Responsible Authority Certification Stormwater Pollution Prevention Plan

e INCEPTION, 805-819 WEST UNIVERSITY AVENUE City of Gainesville, Alachua County, Florida

Combination penalty of lay they be described and all attachments were proposed under any discoption or assessment in assessment as system enterpret to assess that launch appeared per a companie of the companies and an experience of the companies and an experien

NAME (RESPONSIBLE AUTHORITY) DATE

Contractor/Subcontractor Certification Statement Stormwater Pollution Prevention Plan Site: INCEPTION, 805-819 WEST UNIVERSITY AVENUE City of Gainesville, Alachua County, Florida Contracting Firm: NAME OF LADONESS

THEOREM SUMMER

NAME	TITLE	
ADDRESS		

	Pollution Proven Importion Report	tion Plan
Date	·	Time:

	Stabilization Measures		
LOCATION	CONDITION	ACTION REQUIRED	

Results of Previous Recommended Actions:

Note: To be completed every 7 days and within 24 hours of a rainfall event of 0.25 inch or more.

DEIGHE OFFICE				
LOCATION/TYPE	CONDITION	MAINTENANCE REQUIRED		
f no maintenance required, mark "N.A."				
Recommended Actions:				

Other	Centrel

CONDITION

	6000	FAIR	POOR
Condition of construction entrance/exit?			
Condition of construction occess road surface?			
General oppearance of site re: trash and debris.			
Appearance of portobles for sanitary discharge?			
Moteriots available for emergency split response?			
Paint/deaning compound storage areas condition?			
Loy-down orea condition?			

Results of Previous Recommended Actions:

____ Date;___

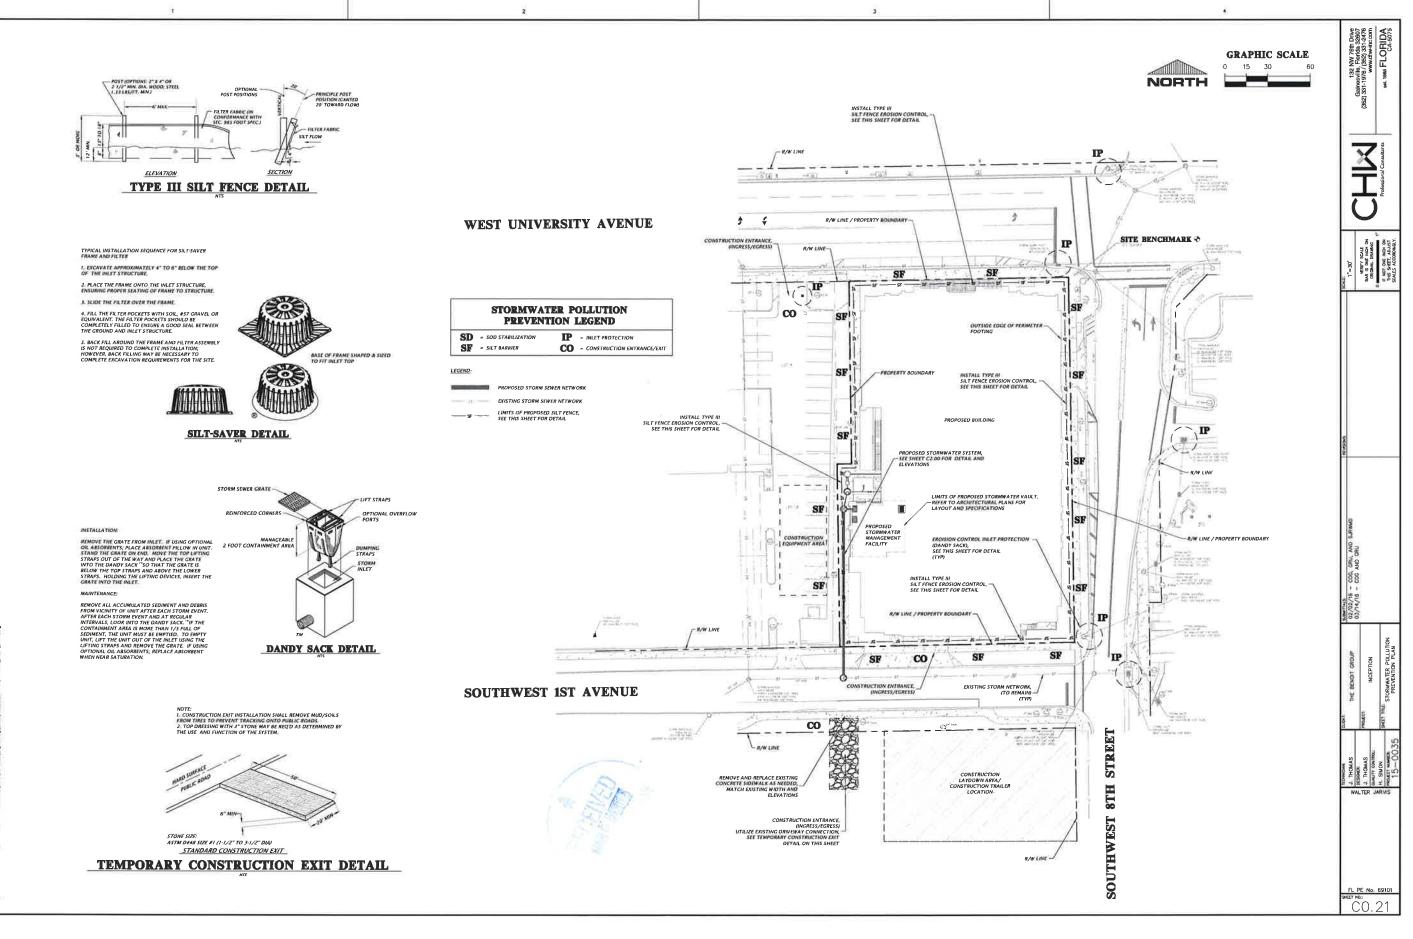
The above agreements into County that this Society is a compliance with the Forementer Inflation Pre-worker Flan and the State of Florida Generic Permit for Stormwater On charge from Lung- and Small Construction Artemate it them are not any incidents of non-compliance identified above.

132 NW 76th D Gainesville, Florida 32 (352) 331-1976 / (352) 331-3 www.chw-inc.

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C0.20



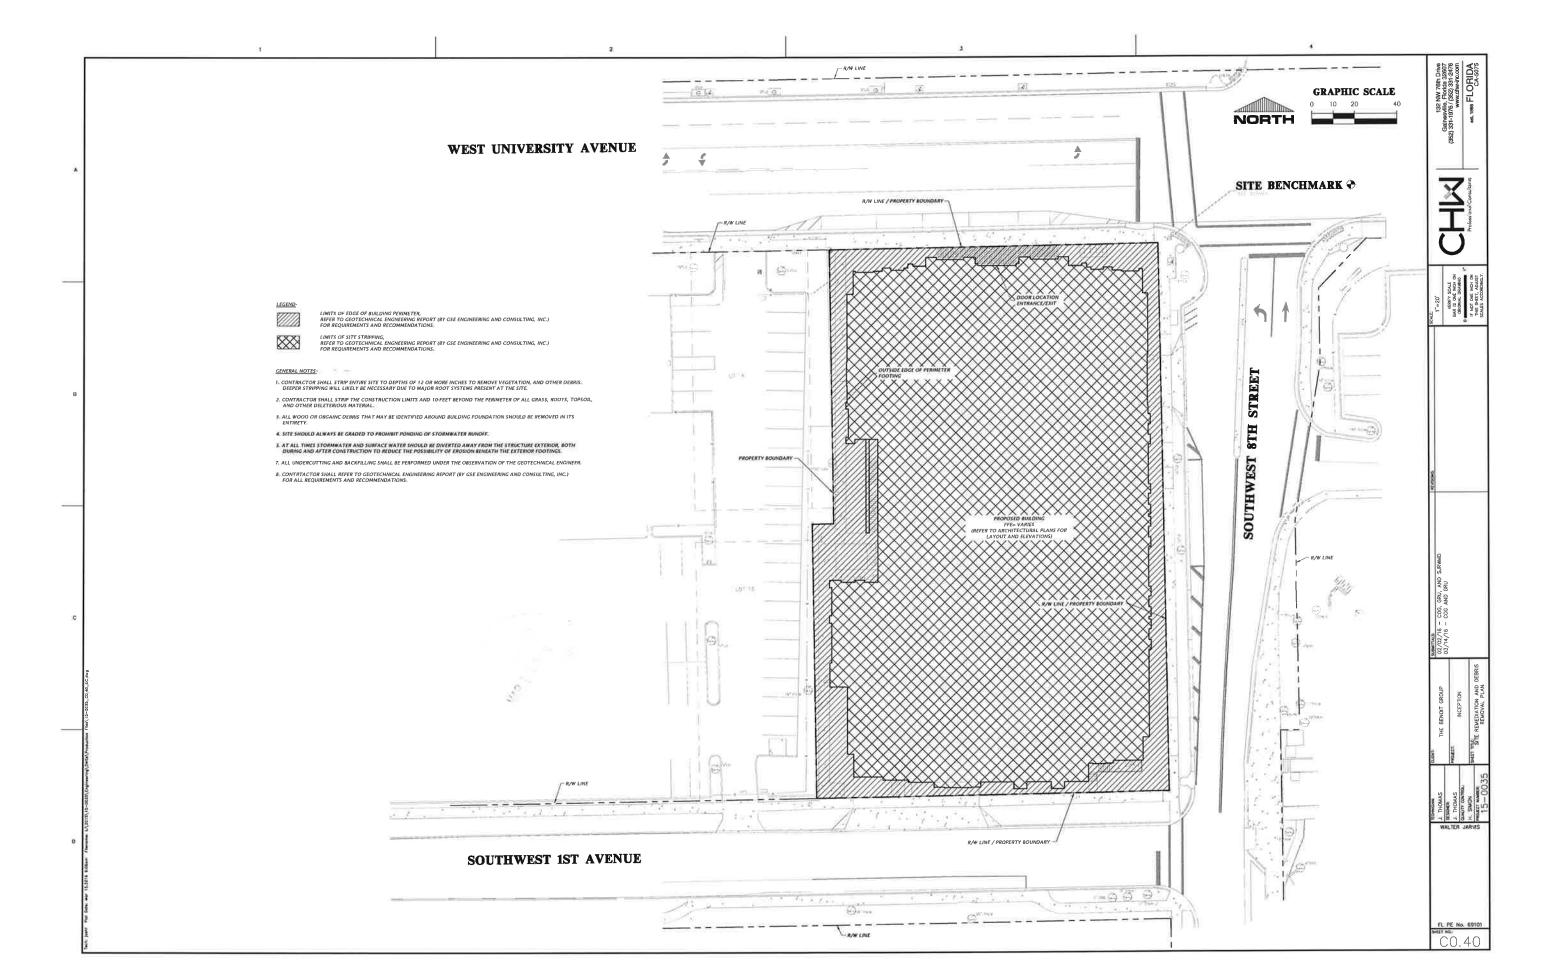
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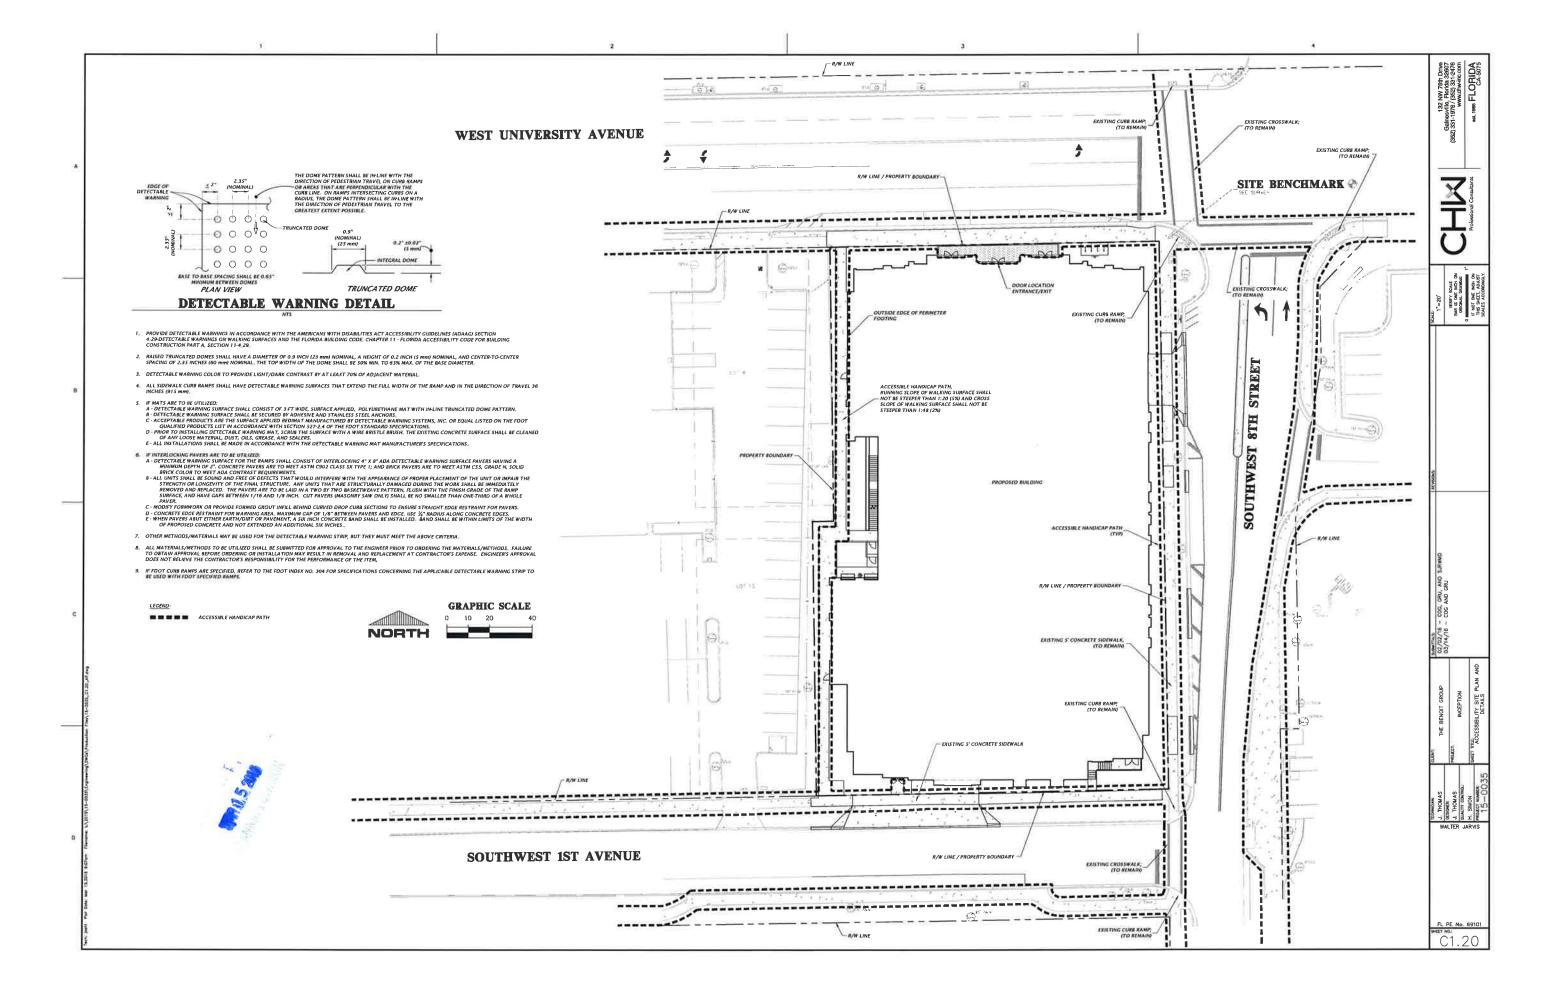
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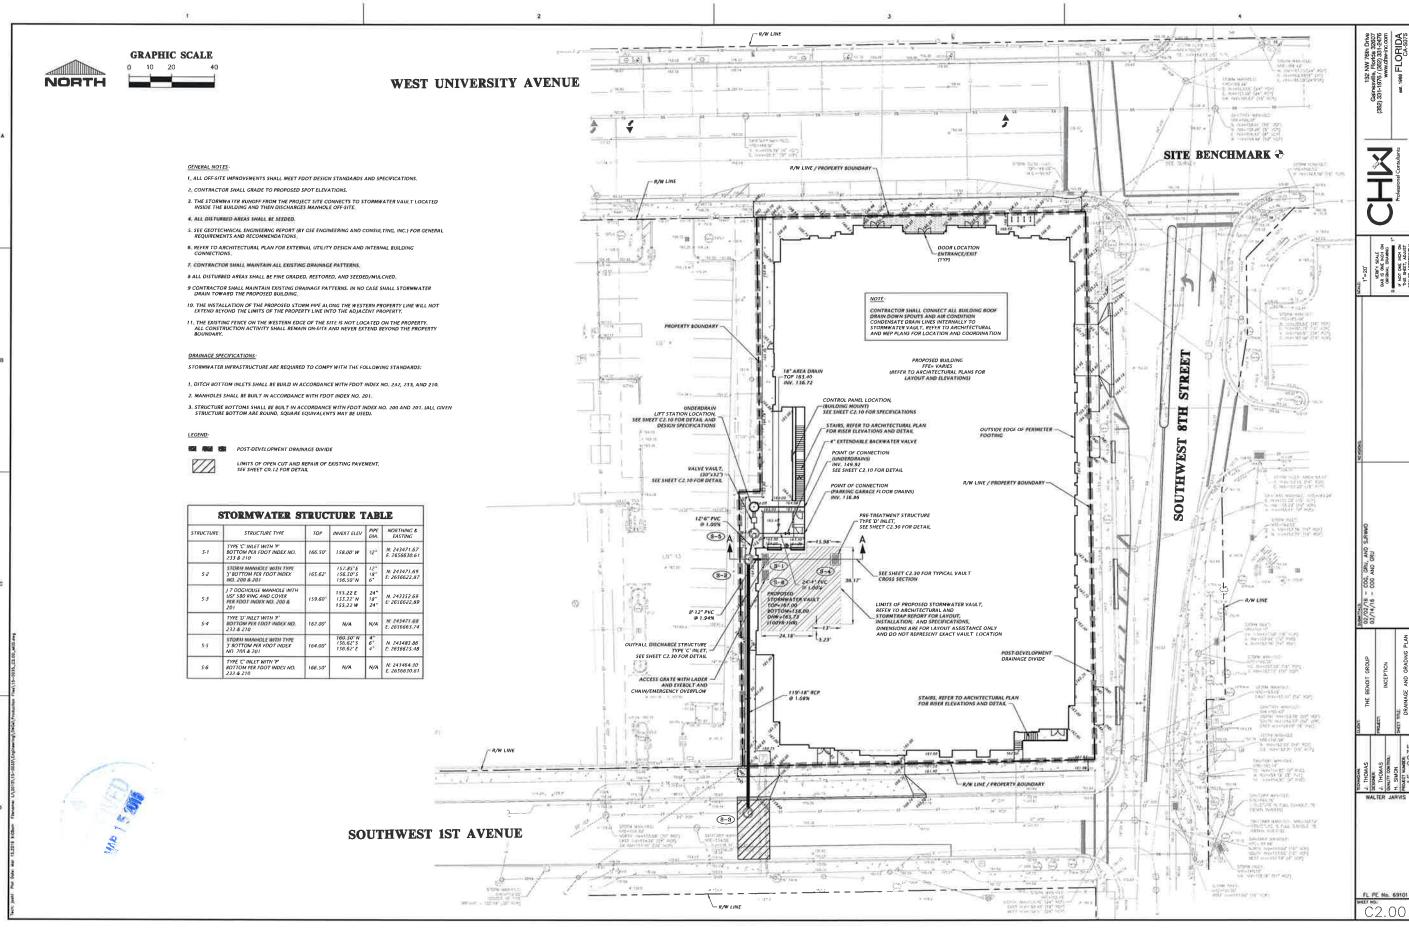
132 NW 76th Drive Gainesville, Florita 32607 (352) 351-1976 (352) 351-1676 900 1890 (352) 351-1676 601 1896 FLORIDA 601 1898 FLORIDA CA-5075 R/W LINE GRAPHIC SCALE 10 20 EXISTING WATER METER, (TO BE REMOVED) COORDINATE WITH GRU WATER INSPECTOR 7 DAYS IN ADVANCE (TYP OF 4 WATER METERS) EXISTING WATER SERVICE LINE, (TO BE REMOVED) COORDINATE WITH GRU WATER INSPECTOR 7 DAYS IN ADVANCE NORTH WEST UNIVERSITY AVENUE 子と SITE BENCHMARK dans of the STREET a Comr EXISTING SS LATERAL, (TO BE REMOVED) X GENERAL NOTES LOT 2 8TH SOUTHWEST Bog GH S. FOR TREE SIZE AND TYPE REFER TO SURVEY SHEETS. EXISTING WATER METER, (TO BE REMOVED) CAP/PLUG EXISTING LINE COORDINATE WITH GRU WATER INSPECTOR 7 DAYS IN ADVANCES 1-STORY CONC. BLOCK STRUCTURE 6. ONLY TREES DEPICTED TO BE REMOVED ARE TO BE REMOVED DURING CONSTRUCTION OF THE DEVELOPMENT. 7. CONTRACTOR SHALL CONTACT AND COORDINATE WITH ALL UTILITY COM-DEMOLITION OR RELOCATION OF ALL EXISTING UTILITIES PROPERTY ROUNDARY EXISTING SANITARY SEWER C/O AND LATERAL, (TO BE REMOVED (TO BE REMOVED) EXISTING TREE, (TO BE REMOVED) SAWCUTLINE EXISTING ASPHALT PAVEMENT AND DOUBLE YELLOW STRIPE, (TO BE REMOVED) 144,44 LIMITS OF OPEN CUT AND REPAIR OF EXISTING P. SEE SHEET CO. 12 FOR DETAIL T PANE LOT 16 COMPRES SAWCUT LINE SOUTHWEST 1ST AVENUE EXISTING WHITE STOP BAR, (TO BE REMOVED) (TYP OF 2) EXISTING SANITARY SEWER C/O AND LATERAL, ITO BE REMOVED; CUT AND CAP AT BACK OF CURB, COORDINATE WITH GRU WASTEWATER INSPECTOR AR HOURS IN ADVANCE FL PE No. 69101 EXISTING OVERHEAD WIRE, (TO BE RELOCATED) - N/W LINE

C0.30

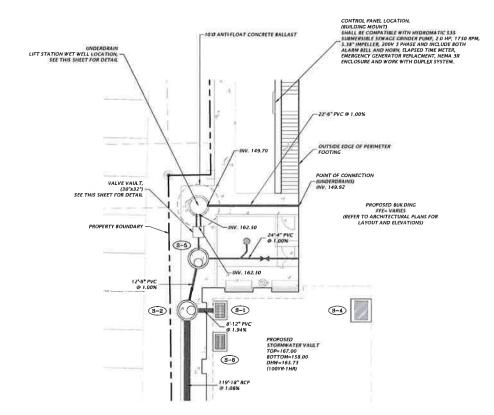


132 NW 78th Drive Gainssville, Florida 32607 (352) 381-1976 (352) 381-2476 WWWWW-incom ear, 1868 FLORIDA CA-5075 GRAPHIC SCALE 0 10 20 NORTH WEST UNIVERSITY AVENUE 子と SITE BENCHMARK 🏵 GENERAL NOTES I. SITE LIGHTING TO BE PROVIDED BY POLE MOUNTED LIGHTING FIXTURES SEE SHEET E-I FOR DESIGN AND SPECIFICATIONS. 2. SEE GEOTECHNICAL ENGINEERING REPORT (BY GSE ENGINEERING AND CONSULTING, INC.)
FOR GENERAL REQUIREMENTS AND RECOMMENDATIONS. 5. REFER TO C1.20 FOR HANDICAP ACCESSIBILITY PLAN LEGEND-STREET 8TH PROPERTY BOUNDARY LIMITS OF PROPOSED BUILDING.
REFER TO ARCHITECTURAL PLANS FOR LAYOUT AND ELEVATIONS SOUTHWEST 18 OUTSIDE EDGE OF PERIMETER 5' SIDEWALK -EXISTING 2" CURB AND GUTTER,
(TO REMAIN)
(TYP)
24" WHITE S SIDEWALK SOUTHWEST 1ST AVENUE TYPE 'F' CURB AND GUTTER, -






GRAPHIC SCALE 0 10 20 NORTH




UNDERDRAIN LIFT STATION SITE/CIVIL PLAN

STORMWATER STRUCTURE TABLE					
STRUCTURE	STRUCTURE TYPE	TOP	INVERT ELEV	PIPE DIA.	NORTHING & EASTING
5.5	STORM MANHOLE WITH TYPE 'J' BOTTOM PER FDOT INDEX NO. 200 & 201	164 00'	156.62'S 156.62'E	6° 4°	N: 243483.86 E: 2656625.48

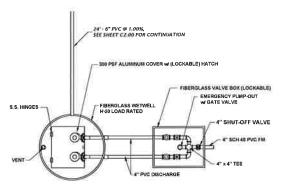


UNDERDRAIN LIFT STATION PLAN

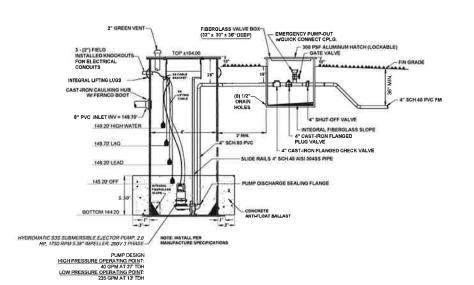

UNDERDRAIN LIFT STATION PLAN

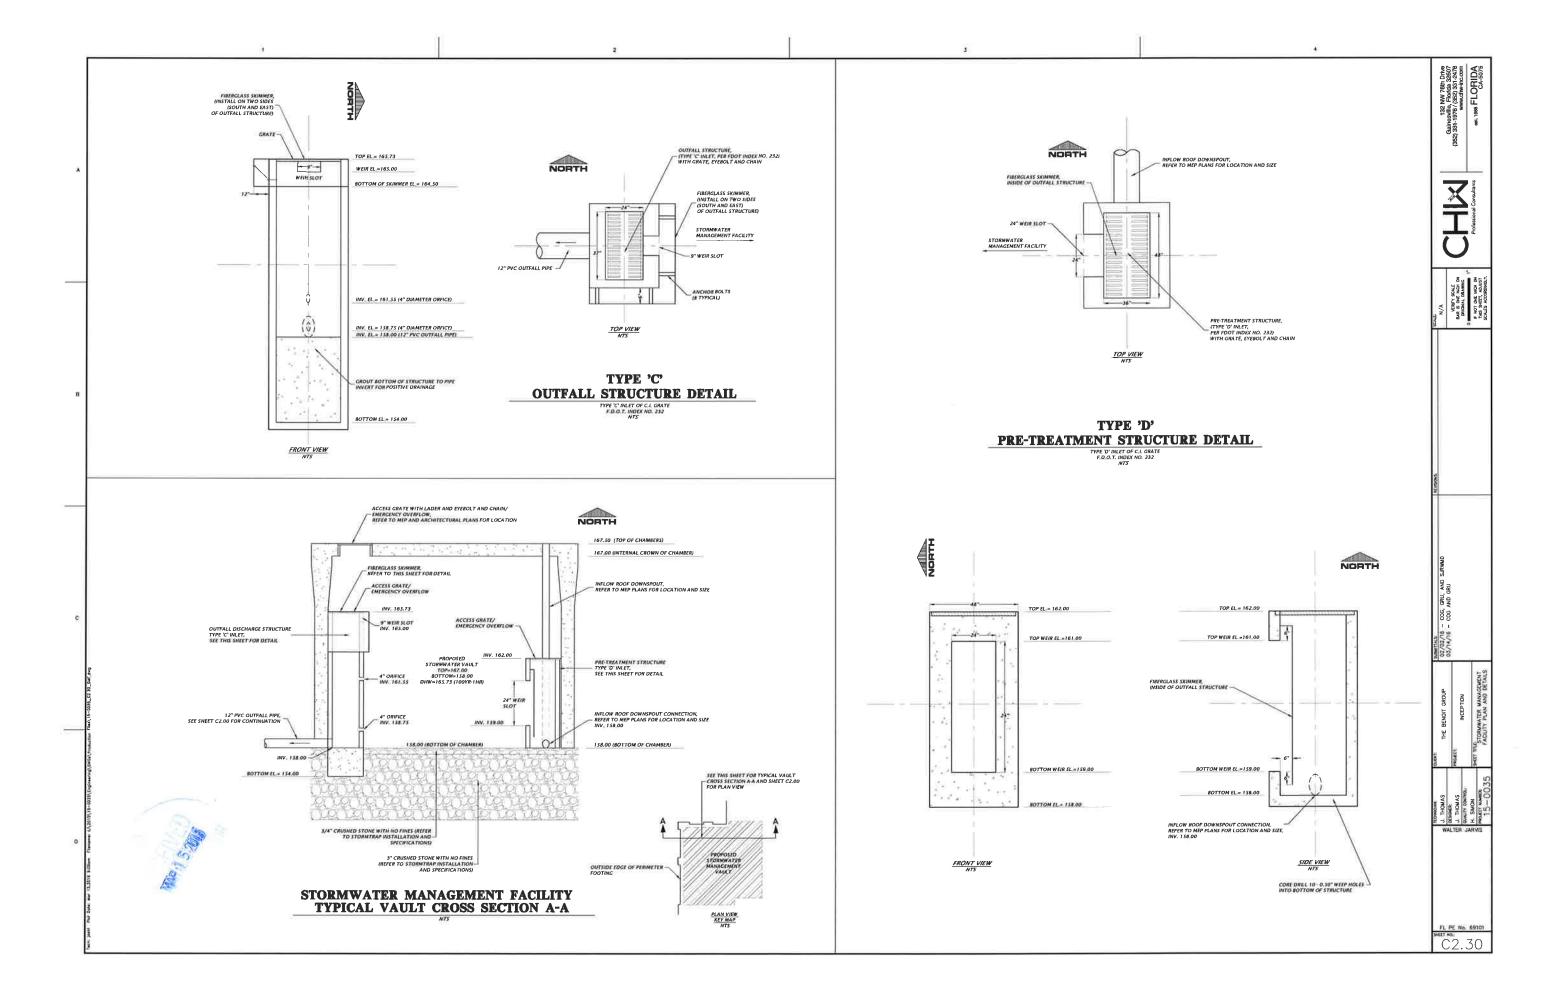FL PE No. 69101 SHEET NO. C2.10



GENERAL NOTES
ALL ASPAUL, LIMEROCK, AND CONSTRUCTION DEBRIS TO BE REMOVED FROM PLANTING
BEDS AND AREAS TO BE SODDED PRIOR TO LANDSCAPE INSTALLATION. PLANTING DEPTH
OF SON IN SUCH AREAS SHOULD FAIR LEAFT IS, IF FILL MUST BE ADDED, IT MUST BE
FINDING ALEAN DEEP FILL (FIRE OF WEED SEEDS) WITH pt 5.5-6.5.

ALL TREES TO BE A MINIMUM SEVEN (7) FEET IN HEIGHT AND TWO (2) INCH CALIPER, OR LARGER, UNLESS OTHERWISE SPECIFIED BY THE LANDSCAPE ARCHITECT.

ALL TREES TO BE PLANTED 1"-2" ABOVE FINISHED GRADE.

ALL LANDSCAPED AREAS SHALL BE MULCHED WITH 3" THICKNESS OF MULCH. PINE BARK MULCH SHALL BE USED IN ALL AREAS, EXCEPT RETENTION AREAS. PINE STRAW MULCH SHALL BE USED IN RETENTION AREAS.

TREES OUTSIDE OF MULCHED LANDSCAPED BEDS TO BE PROTECTED FROM MOWER AND STRING TRIMMER CAUGES WITH 10° OF PLASTIC DRAIN TUBE.

LEADER SHOOTS AND MAIN STRUCTURAL LIMBS OF TREES WILL NOT BE TOPPED OR PRUNED, TREES TO BE STAKED AS NEEDED, GUYLINES TO BE NON-SYNTHETIC BIODEGRADABLE MATERIAL.

OWNER SHALL BE RESPONSIBLE FOR (1) THE SURVIVAL OF THE LANDSCAPING ELEMENTS AND (2) REMOVAL OF ALL STAKING SYSTEMS WITHIN ONE YEAR. TREES WILL BE STAKED ONLY IF RECESSARY, AND IF STAKED, BIODEGRADABLE TWINE WILL BE USED.

CALL THE URBAN FORESTRY INSPECTOR FOR A BARRICADE INSPECTION AT 352-393-8188 BEFORE CLEARING AND GRUBBING WORK BEGINS.

ALL INVASIVE PLANT SPECIES TO BE REMOVED FROM SITE PRIOR TO ISSUANCE OF THE CERTIFICATE OF OCCUPANCY

PLANT MATERIAL. TO BE FLORIDA NO.1 OR BETTER, GRADED IN ACCORDANCE WITH THE STATE OF FLORIDA DEPARTMENT OF AGRICULTURE, DINSION OF PLANT INDUSTRY'S 'GRADES AND STANDARDS FOR NURSERY PLANTS'. CALL THE CITY URBAN FORESTRY INSPECTOR AT 352—393—3188 AND LANGSCAPE ARCHITECT PRIOR TO PURCHASING ANY PLANT MATERIAL FOR AN ON SITE INSPECTION AND REVIEW OF LANDSCAPE PLAN.


<u>IRRICATION</u>

LANDSCAPE IRRICATION TO BE PROVIDED BY AUTOMATIC IRRICATION SYSTEM, BUBBLERS
SHALL BE INSTALLED BY EACH TREE AS PART OF THE IRRICATION SYSTEM.


EXISTING TREES TO REMAIN

I.M.P.A.
SITE IS LOCATED IN ZONE A OF THE TRANSPORTATION MOBILITY PROGRAM AREA.

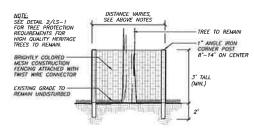LEGEND 0



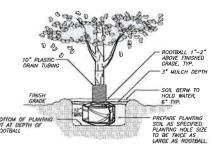STANDARD TREE PROTECTION DETAIL -1 REGULATED, NON-HIGH QUALITY HERITAGE



TREE PROTECTION NOTES


- 1. REGULATED TREES TO REMAIN THAT ARE WITHIN 50 FEET OF ANY CONSTRUCTION ACTIVITY OR STORAGE OF EQUIPMENT OR MATERIALS SHALL BE PROJECTED BY A TREE PROTECTION BARRIER.
- TREE BARRIERS SHALL BE PLAINLY VISIBLE AND SHALL CREATE A CONTINUOUS BOUNDARY AROUND TREES TO REMAIN TO PREVENT ENCROACHMENT BY MACHIMERY. NO CONSTRUCTION EQUIPMENT, MATERIALS, SUPPLIES, FUELS, OR CHEMICALS SHALL BE STORED WITHIN THE BARRICADE LUMITS AT ANY TIME.
- 3. BARRIERS SHALL BE PLACED AT OR OUTSIDE THE DRIP LINE FOR HERITAGE AND CHAMPION TREES AND ALL REGULATED PINE AND PALM TREES. FOR ALL OTHER REGULATED TREES TO REMAIN, TREE BARRIERS SHALL BE LOCATED AT TWO-THIERD THE AREA OF THE TREE ORIPLINE OR AT THE ROOT PLATE AT A MINIMUM AND WITH CITY UTBAN FORESTER WISPECTOR APPROVIA.
- NO GRADE CHANGES SHALL BE MADE WITHIN THE PROTECTIVE BARRIER ZONES WITHOUT PRIOR APPROVAL OF THE CITY MANAGER OR DESIGNEE.
- 5. TREE BARRICADES SHALL REMAIN IN PLACE AND IN WORKING ORDER THROUGHOUT CONSTRUCTION. BARRICADES SHALL BE REMOVED ONCE MAJOR CONSTRUCTION OF THE PROPERTY OF
- A LAYER OF WOOD CHIPS AT LEAST EIGHT (8) INCHES THICK SHALL COVER THE SOIL WITHIN THE TREE BARRICADE AREA.
- WHERE ROOTS GREATER THAN ONE (1) INCH ARE DAMAGED OR EXPOSED, THEY SHALL BE CUT CLEANLY AND RE-COVERED WITH SOIL WITHIN ONE HOUR OF DAMAGE OR EXPOSURE.
- ON EMPOSONE.

 B. CONTRACTOR SHALL TRIM ONLY THOSE EXISTING TREES AS NOTED ON THE PLAN OR AS APPROVED BY OWNER'S REPRESENTATIVE AND LANDSCAPE ARCHITECT.

 TRIMMING/PRUNNING SHALL BE DONE IN ACCORDANCE WITH THE MOST CURRENT VERSION OF THE AMERICAN NATIONAL STANDARD FOR TIRE CARE OPERATIONS. TITLE, STRING, AND OTHER WOODY PLANT MAINTENANCE (MAS) 300 AND "PERINNING, TREES, AND CUTTING BRUSH, TRIMMING, REPAIRING, MAMMAINING, AND REMOVING TREES, AND CUTTING BRUSH, THAN AS TO THE CROWN AT ONE TIME. (AND STATE) RESOURCE THAN 250 OF THE CROWN AT ONE TIME. (SOURCE THAN 250 OF THE CROWN AT ONE TIME.)

 BURGHERSTRONG CORPORATION OF THE CONTROL THAN AS OF THE TRUNK OF PRESENTATION OF THE CROWN ACCOUNTS WITH OWNERS THE CONTROL THAN AS OF THE CROWN ACCOUNTS WITH OWNERS THE CONTROL THAN ASSOCIATIONS WITH OWNERS REPRESENTATION OF THE OWNERS WERE CONTROLLED FROM THE OWNERS WITH OWNERS.
- 9. STANDAND TIKE PROTECTION BARRER FOR REGULATED THEES THAT ARE NOT NOT-DUALITY HERITAGE. SET DETAIL IAS—I: BARRICADES TO BE A MINIMUM OF THREE (3) FEST TAIL AND CONSTRUCTED OF EITHER 2X WOODEN CORPIER POSTS BURIED TO ONE FOOT DEPTH WITH AT LEAST TWO COURSES OF 1X4 WOODEN SIDE SLATS WITH COLORDED FACEORING/COLORDED MESH ATTACHED OR CONSTRUCTED OF ONE-INCH ANOLE IRON CORNER POSTS WITH BRIGHTLY COLORDED WESH CONSTRUCTOM FERCING ATTACHED. SEE NOTE 10 FOR ADDITIONAL REQUIREMENTS FOR HIGH—QUALITY HERITAGE TIREE BARRIERS.
- 10. CALL PLANNING SERVICES AT 352-393-8188 TO SCHEDULE A BARRICADE INSPECTION BEFORE ANY CLEARING AND GRUBBING WORK BEGINS.

CATEGORY	MITIGATION CALCULATIONS
TREE APPRAISED VALUE	TOTAL TREES IN CATEGORY TO BE MITIGATED. 2 TREES MAXIMUM 3 TREES PLR ACRE: TOTAL SITE AREA 0.63 ACRES MAXIMUM APPRAISED TREES. 2 TREES TREES BEYOND MAXIMUM TO BE MITIGATED INCH FOR INCH. 0 TREES APPRAISED TREES: 32* LIVE OAK - \$17.884.48 \$ 24* PECSH - \$9.927.52 TOTAL = \$27.632.00
INCH-FOR-INCH REPLACEMENT	HIGH-QUALITY HERITAGE TREES BEYOND MAXIMUM O SPECIES
2:1 REPLACEMENT	TOTAL TREES TO BE MITIGATED AT 2:1 REPLACEMENT
TOTAL TREE MITIGATION	TOTAL MITIGATION INCHES REQUIRED
TOTAL MITIGATION PAYMENT	TOTAL MITIGATION PAYMENT: TREE APPRAISALS TOTAL \$27,632.00 DEFICIT PAYMENT (\$100/TREE) \$5,000.00 TOTAL PAYMENT REQUIRED. \$33,232.00 * MOTE: MITIGATION PAYMENT SHALL BE MADE PRIOR TO

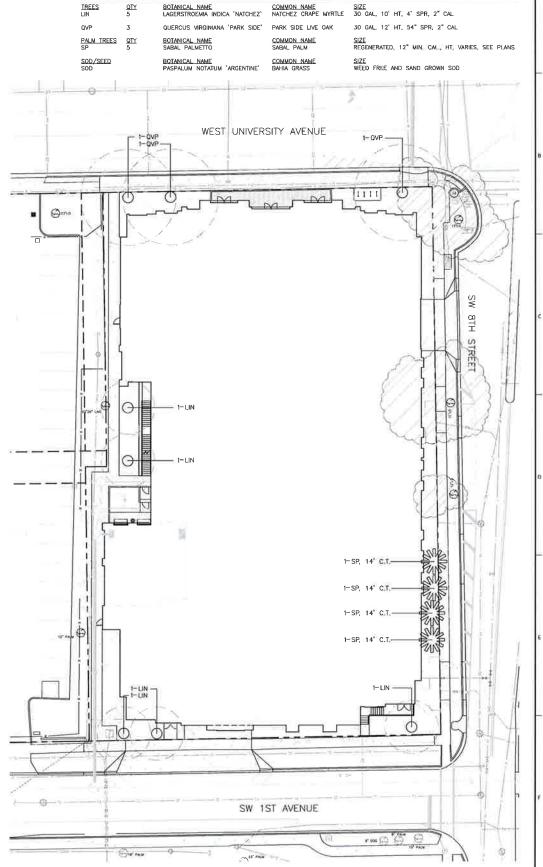

PLANT SCHEDULE

2406 NW 43rd Street Gainesville, Florida 32606 352 335 1896 tel 352 373 6407 fax Certificate of Authorization No. 000003

INCEPTION
USE DEVELOPMENT
NIVERSITY AVENUE & SW 8TH STREET
GAINESVILLE, FLORIDA MIXED N

CONSULTANT

SEAL:

PROJECT NO: 16-004 LFH/CMT DRAWN BY: EJB3 CHECKED BY DATE: 02 FEB 2016 REVISIONS: 15 MAR 2016 DRAWING SCALE: DRAWING TITLE LANDSCAPE PLAN ISSUED FOR:

2 TREE PLANTING DETAIL

LS-1 SHEET: 1 OF 1

SITE PLAN REVIEW

DRAWING NUMBER:

3,0 23 21 20 19 18 17 16 15 15 15 15 15 16 16 16 16 16 16 14 66 64 48 40 34 34 29 27 27 28 20 19 18 18 19 21 26 25 24 24 24 25 11 15 15 15 *122 *11,4 *69 *54 *51 *60 *48 *42 *45 *53 *38 *28 *24 *22 *23 *27 *33 *49 *45 *38 *39 *50 *39 *26 *19 *17 *102 *95 *65 *59 *67 | 199 *69 *67 *64 | 193 *56 *37 *28 *25 *27 *33 *46 *18 *69 *53 *56 *18 *61 *34 *23 *1.7 *46 *49 *46 *49 *59 *78 *62 *53 *58 *7.3 *51 *35 *27 *24 *26 *32 *43 *68 *62 *49 *51 *69 *54 *31 *22 *1.7 *26 *29 *32 *35 *40 *48 *42 *39 *40 *44 *34 *28 *24 *20 *21 *26 *31 *41 *39 *36 *36 *41 <u>*33</u> *22 *17 <u>*1.5</u> 20 22 25 28 31 36 34 34 33 33 28 26 17 16 18 17 27 31 32 31 31 31 25 15 14 12 17 20 24 28 36 45 41 39 39 42 33 29 *32 *40 *39 *37 *39 *43 *14 *10 *1.0 *1.0 *12 *14 *20 *35 *55 *76 *62 *54 *58 *71 *51 *38 *29 *26 *28 *33 *46 *68 *63 *53 *57 *77 *72 098 *75 63 69 088 61 41 32 28 30 38 52 404 76 61 67 406 *77 *76 *59 *51 *53 *63 *46 *34 *29 *26 *28 *33 *41 *60 *56 *49 *52 *67 *50 *74 *534 *148 *83 *56 *43 *39 *38 *39 *32 *28 *26 *25 *26 *27 *30 *37 *37 *36 *37 *41 *8.4 - 9.7 *11.5 *11.1 *7.2 *5.3 *4.2 *3.8 *3.6 *3.5 *3.0 *2.7 *2.6 *2.5 *2.5 *2.7 *2.9 *3.4 *3.4 *3.4 *3.4 *3.8 **\$\big2 ^139 ^109 ^9:4 ^7.5 ^7.0 ^5.4 ^4.7 ^4.7 ^5.3 ^4.0 ^3.2 ^2.8 ^2.6 ^2.7 ^3.1 ^3.6 ^5.0 ^4.7 ^4.2 ^4.3 ^5.1 ^4.0 ^2.8 ^2.2 ^1.9 *11.9 *11.3 *89 *82 *82 | 19.7 *7.4 ,*6.1 *6.7 | 193 *58 *40 *32 *29 *30 *3,7 *49 *1/19 *7,1 *56,/*59 *1/19 *65 *63 *60 *63 *72 *91 *7.1 *60 *65. *82 *58 *40 *32 *28 *30 *37 *49 *77 *70 *56 *58 *78 *62 *37 *27 *21 *35 *40 *44 *48 *57 *49 *44 *46 *51 *40 *32 *28 *26 *27 *30 *36 *49 *46 *41 *42 *49 *39 *28 *23 *20 *27--*31 -*33 *35 *39 *37.-*35 *35 *35 *35 *30 *28 *26 *25 *27 *28 *33 *34 *33 *32 *33 *28 *24 -*21 *19 *24 *26 *31 *36 *42 *39 *37 *38 *40 *33 *29 *27 *26 *26 *28 *31 *38 *37 *35 *35 *38 *32 *25 *22 *19 *24 -*29 -*3.6 -*4.8 *6.6 *5.5 *4.9 *5.3 *6.4 *4.7 -*3.6 *3.0 *2.8 *2.9 -*3.3 *4.2 *8.1 *5.7 *4.8 *4.9 *6.2 *4.9 -*3.3 -*2.6 -*2.1 *25 *31 *41 *60 88 *70 \$\frac{1}{60}\$ *68 88 *61 *41 *32 *29 *31 *38 *51 *84 *7.6 *59 *61 *85 *67 *3.9 *28 *2.2 *24 *28 *36 *49 *69 *57 *51 \$66 *69 *50 *37 *30 *28 *29 *34 *44 *66 *60 *50 *51 *66 *53 *34 *26 *21 *23 *25 *28 *34 *41 *3.8 *3.7 *3.8 *41 *3.4 *29 *27 *26 *26 *28 *32 *40 *39 *36 *37 *40 *33 *26 *23 *20 *22 *24 *26 *29 *34 *33 *33 *33 *33 *33 *29 *27 *26 *25 *26 *28 *33 *33 *32 *32 *32 *28 *24 *21 *19 *23 *26 *30 *36 *46 *42 *39 *41 *47 *37 *31 *28 *26 *27 *30 *34 *45 *43 *39 *40 *45 *37 *28 *23 *20 24 28 37 53 76 61 54 60 76 54 38 31 28 30 36 47 74 67 54 56 74 59 36 27 21 *24 *29 *39 *57 84 *67 *57 *65 84 *59 *40 *3.2 *29 *3.1 *3.8 *50 *8.1 *7.3 *57 *60 *82 *65 *38 *28 *22 *23 *26 *32 *41 *55 *47 *44 *47 *55 *42 *33 *29 *27 *28 *32 *38 *54 *50 *44 *45 *54 *43 *30 *25 *20 *22 *24 *26 *30 *35 *34 *33 *34 *35 *30 *27 *26 *25 *26 *27 *29 *35 *35 *33 *33 *34 *29 *24 *22 *19 *22 *24 *27 *30 *36 *34 *34 *34 *36 *31 *28 *26 *25 *26 *27 *29 *35 *35 *34 *34 *35 *30 *25 *22 *1.9 *23 *27 *32 *42 *57 *49 *45 *48 *57 *43 *33 *29 *27 *28 *32 *39 *55 *51 *45 *46 *56 *45 *31 *25 *21 = *25 *30 *39 *58 \$85 *68 \$56 *66 \$85 *59 *40 *32 *28 *30 *38 *51 *\$2 *74 *58 *60 *\$3 *66 *39 *28 *22 *25 - 29 - 3.7 - 5.2 - 7.5 - 61 - 54 - 60 - 7.5 - 5.3 - 3.8 - 3.0 - 2.7 - 2.8 - 3.5 - 4.6 - 7.2 - 6.5 - 5.3 - 5.5 - 7.2 - 5.7 - 3.6 - 2.7 - 2.1 - 5.7 - 2.7 - 2.8 - 3.6 - 2.7 - 2.1 - 5.7 - 2.7 - 2.8 - 3.6 *25 *28 *31 *37 *47 *42 *40 *41 *45 *36 *30 *27 *25 *25 *27 *33 *44 *42 *38 *39 *44 *36 *27 *23 *20 🗓 *27. *30. *32. *34. *38. *36. *35. *34. *34. *29. *26. *24. *23. *22. *24. *33. *33. *32. *32. *32. *26. *24. *21. *1.9 *32 *40 *48 *47 *52 *45 *41 *41 *43 *35 *29 *25 *22 *19 *16 *18 *45 *42 *38 *37 *41 *34 *26 *23 *20 -4:1-6.6 -8:4 -7.8 8.8 6.8 5.5.7 60 72 5:1 3:6 29 23 82 67 52 53 68 54 35 26 21 *9.6 11.7 10.2 11.1 82 66 7.1 189 61 40 29 24 *80 60 62 84 67 39 28 22 68 62 54 55 64 47 34 27 23 21 23 35 62 57 48 48 60 48 32 26 21 *39 *37 *37 *38 *40 *33 *28 *26 *24 *23 *26 *30 *37 *37 *35 *35 *36 *31 *25 *22 *20 *38 *37 *36 *35 *36 *31 *28 *26 *25 *25 *27 *29 *33 *33 *32 *32 *33 *28 *24 *22 *19 *38 *42 *48 *59 *51 *46 *48 *54 *42 *33 *29 *27 *28 *31 *36 *50 *46 *41 *41 *49 *40 *29 *24 *20 *54 *61 *73 ¶96 *76 *64 **70 ¶97 *61 *42 *34 *30 *31 *37 *49 *¶8 *7.0 *54 *67 *¶8 *62 *37 *27 *21 *82 *87 *86 *106 *83 *7.0 *75 *92 *65 *45 *35 *30 *31 *36 *47 *75 *68, *53 *55 *7.5 *60 *38 *20-*104 *104 *66 *96 *76 *66 *66 *79 *5.7 *42 *34 *29 *27 *29 *33 *45 *41 *36 *37 *44 *3.6 *26 *21 *18 *8.7 *9.0 *8.6 *10.4 *8.2 *7.0 *7.5 *6.0 *6.4 *4.4 *3.4 *27 *24 *22 *23 *25 *24 *23 *23 *24 *21 *1.8 *4.7 *1.8

\$5,6' \$6.4 \$7.5 \$\bigg| 10.0 \$7.9 \$\bigg| 6.8 \$\bigg| 7.4 \$\bigg| 9.2 \$\bigg| 64 \$\bigg| 4.3 \$\bigg| 32 \$\bigg| 2.5 \$\bigg| 2.1 \$\bigg| 1.7 \$\bigg| 1.

39 44 52 65 5.6 5.1 5.3 6.1 4.7 36 28 21 18 16 15 15 14 14



PROJECT #: 113070.00

DRAWN 8Y: Author

CHECKED BY: Checker

NILES BOLTON ASSOCIATES

3060 Peachtree Rd. N.W. Suite 600 Atlanta, GA 30305

T 404 365 7600 F 404 365 7610

www.nilesbolton.com

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SHEET TITLE BASEMENT PARKING GARAGE INTERIOR PHOTOMETRICS

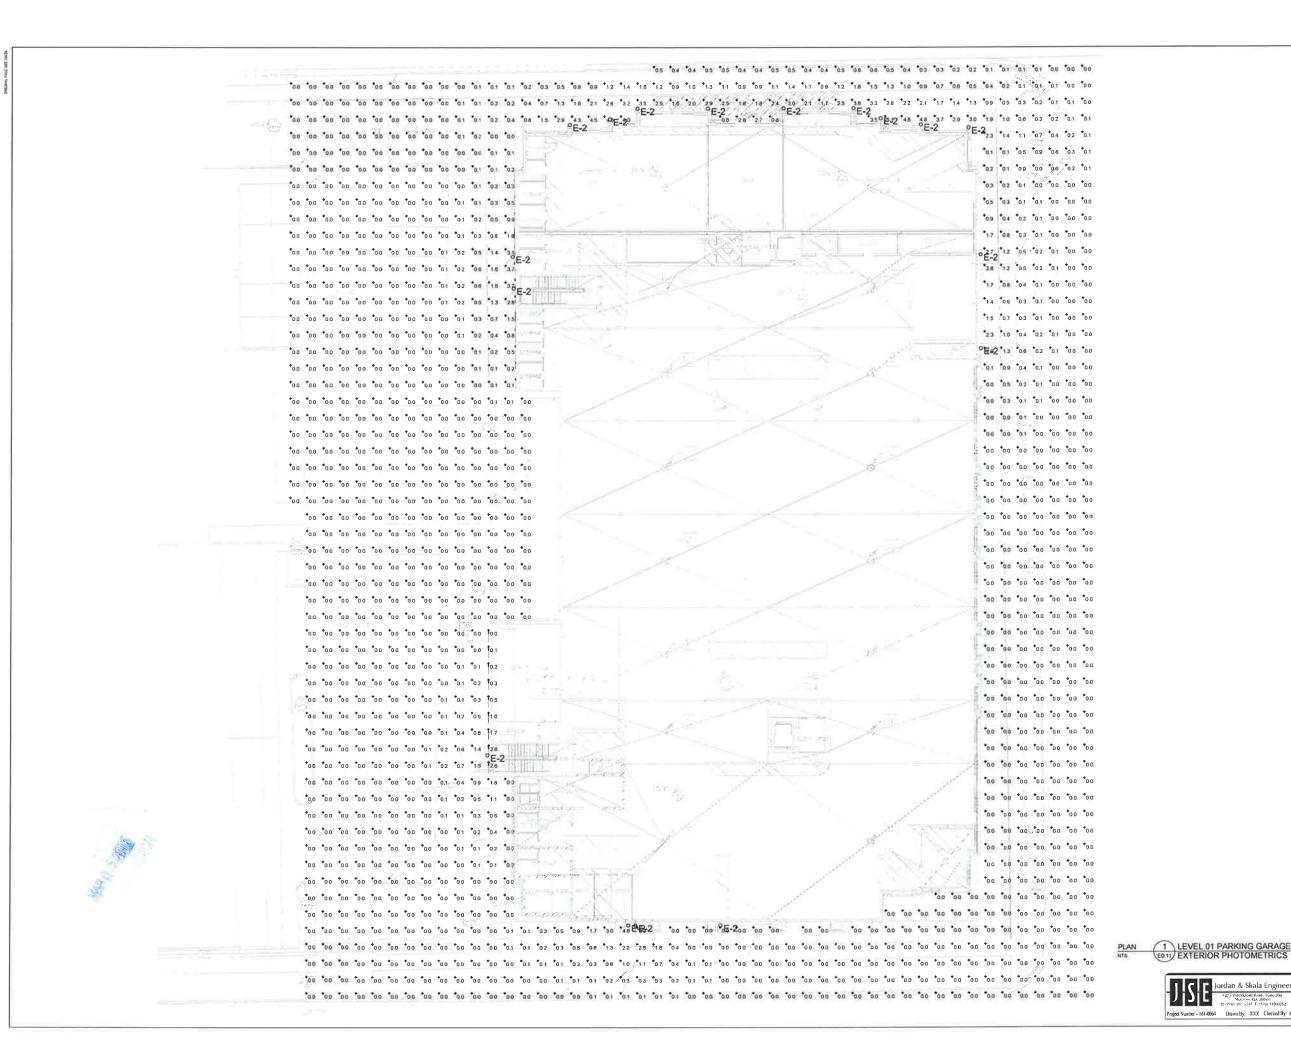
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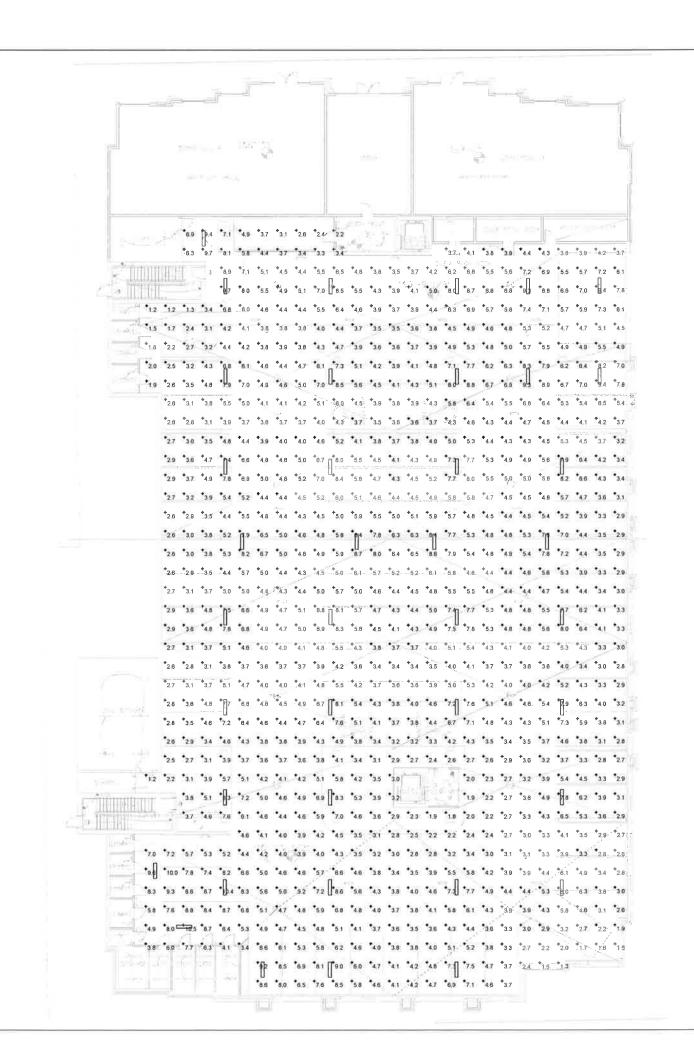
SHEET TITLE LEVEL 01 PARKING GARAGE EXTERIOR PHOTOMETRICS

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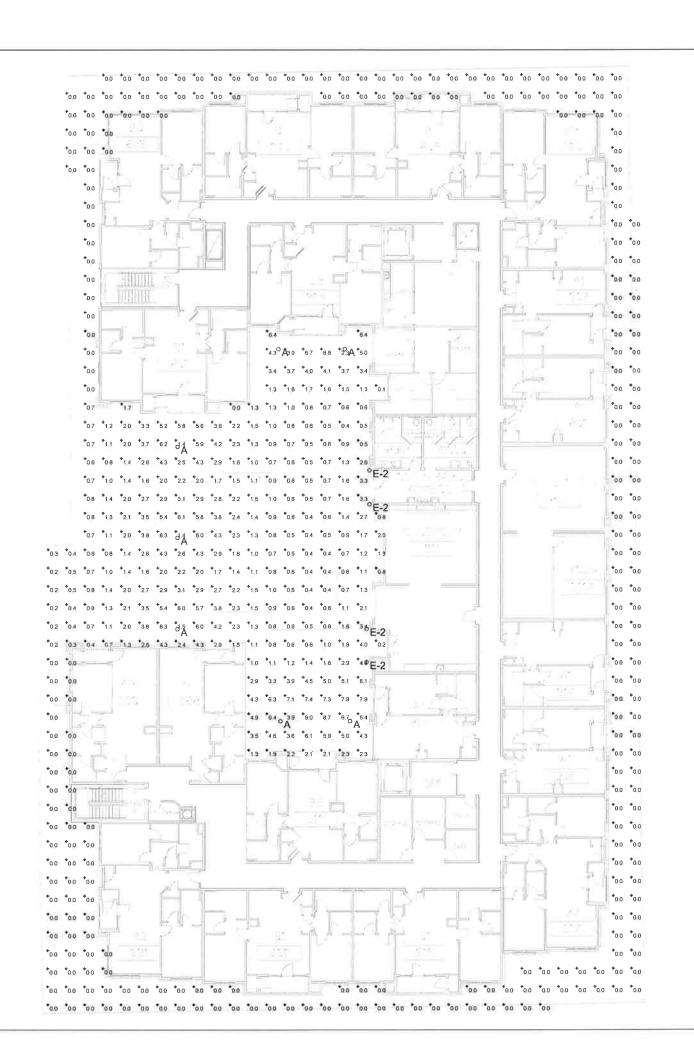
SHEET TITLE LEVEL 01 PARKING GARAGE INTERIOR PHOTOMETRICS

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1 LEVEL 01 PARKING GARAGE E0 12 INTERIOR PHOTOMETRICS

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INNOVATION SQUARE - GAINESVILLE

SHEET TITLE
PODIUM EXTERIOR
PHOTOMETRICS

SHEET NUMBER

E0.13

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1 PODIUM E0.13 EXTERIOR PHOTOMETRICS

I—METER CENTER CONFIGURATIONS SHOWN ON THE RISER DIAGRAMS ARE DIAGRAMMATIC ONLY AN ARE SHOWN FOR DESIGN INTENT, SEE ELECTRICAL ROOM PLANS FOR ALL METER CENTER CONFIGURATIONS INCLUDING ELBOWS.

TVSS NOTE

1-PROVIDE DI-TEK 120V/208 TVSS DEVICES ON ALL FIRE ALRM, SECURITY AND COMMUNICATION CIRCUITS THROUGHOUT THE PROJECT.
2-PROVIDE 60KA PER MODE TVSS DEVICE FOR ALL ELEWATOR FEEDERS.

MULTIPLE SERVICE PLAQUING NOTES

BUILDING WITH MULTIPLE SERVICES, PERMANENT PLAQUES WITH IDENTIFICATION MUST BE PROVIDED PER NEC 230.2 (E) AND 225.37

SHORT CIRCUIT CALULATION NOTES

- TO PRIOR TO ORDERING ELECTRICAL (EAR, CONTRACTOR SHALL CONFIRM ACTUAL SHORT CIRCUIT AVAILABLE AMPS WITH THE EXACT TRANSFORMER SIZE THE UTILITY COMPANY IS FURNISHING.

 AC RATINGS SHOWN ARE ESTIMATED AND BASED ON A 1,500KVA TRANSFORMER WITH B1,000 SHORT CIRCUIT AMPS AVAILABLE.
- ② ESTIMATED MAXIMUM OF 81,000 SHORT CIRCUIT AMPS AT THE TRANSFORMER. 10K AC BREAKERS IN THE APARTMENT LOAD CENTERS SHALL COORDINATE WITH THE 22KA/C METER CIRCUIT BREAKERS WHICH WILL COORDINATE WITH THE 100K A/C SMITCHOARD BREAKERS.
- SESTIMATED MAXIMUM OF 81,000 SHORT CIRCUIT AMPS AT THE TRANSFORMER. 22X/42X AIC BREAKERS IN THE PANELBOARDS. SHALL COORDINATE WITH THE 65K/100K AIC BREAKERS IN THE DISTERIBUTION PANELS AND THE SERVICE SMITCHEODARDS BREAKERS.

SERIES RATED GEAR NOTES

 ALL ELECTRICAL GEAR SHALL BE SERIES RATED. CONTRACTOR SHALL SUBMIT ALL
REQUIRED SERIES RATING SIGNAGE AND SUPPORTING SERIES MANUFACTURER'S DOCUMENTATION TO MEET ALL REQUIREMENTS OF NEC 110.10, 110.22 (B) AND (C) AND NEC 240.86 TO THE ELECTRICAL ENGINEER

METER STACK COORDINATION NOTES

NOTE: RISER DIAGRAM STACKING IS DIAGRAMMATIC ONLY AND IS SHOWN FOR NUMBER OF STACKS AND STACK AMPERAGE, CONTRACTOR SHALL PROVIDE STACKS AS SHOWN ON ELECTRICAL ROOM PLAN LAYOUTS. CONTRACTOR SHALL BALANCE THE LOAD ON BOTH THE RIGHT SIDE AND THE LEFT SIDE OF THE METER GROUP 0

SPOR

MAIN SWITCHBOARD -HOUSE "MSW"

1200A, 208/120V.3ø.4W.60HZ

200A F

ALL SERVICES SHALL BE SERIES RATED

- PRIOR TO FINAL ORDERING OF PANELBOARDS, CIRCUIT BREAKERS, AND ALL ASSOCIATED EQUIPMENT, THE CONTRACTOR SHALL ARRANGE FOR AND PROVIDE TO THE FLECTRICAL ENGINEER OF RECORD WA THE ARCHITECT A LETTER FROM THE CLOAP POWER COMPANY OF THE HETERHEAD STATING THE SORT CIRCUIT FAULT CURRENT AVAILABLE AT THE SECONDARY OF THE UTILITY COMPANY TRANSFORMER, INFORMATION SHALL BE USED TO DETERMINE THE FINAL ALIC, RATINGS OF THE PANELBOARDS, METER CENTERS, MAIN DISCONNECT SWITCHES AND CIRCUIT BREAKERS.
- ESTIMATED 72,000 AVAILABLE SHORT CIRCUIT AMPS— VERIFY PRIOR TO ORDERING GEAR. THE 10 KAVC BREAKERS IN THE LOAD CENTERS, 227AVIC IN THE HOUSE PANELS AND THE 42KAVC BREAKERS AT THE METERS SHALL BE SERIES RATED WITH THE 100AVIC SERVICE MAN BEAKER FOR 100AVIC PROTECTION DOWNSTREAM FROM THE SERVICE MAIN. ALL GEAR SHALL BE ULL LABELED AND LISTED FOR THIS PUMPOSE.

CONTRACTOR SHALL BOND ALL SERVICE GROUNDS TOGETHER.

SEE ELEV SCHEDULE

-00

SCHEDULE OF FEEDERS & SERVICES

	1,66001/36	tryice Description		Number of		COURTCIOL 2018		Conduit
Designation	Equipment Served	Conductor Ampacity (Amus)	Copper or Aluminum	Runs	Phase Conductor	Neutral Conductor	Equipment Ground	Diamete (in)
F 0 00	MCA	1600	AL:	6 sets	3 # 400	1 # 400		- 4
F 0 01	MCB	1600	AL	fi sets	3 m 400	1 # 400		4
F 0 02	RETAIL	629	AL	2 sets	3 at 500	1 at 500	- 4	- 4
F 0 03	SWII	1200	AL.	4 sets	3 # 500	1 # 500		4
F 0 01	P	305	AL	1 set	3 // 250	1 # 250	1 # 4	- 3
F 8 05	A	410	AL	2 sets	3 # 250	1 # 250	1.01	1
F 0 06	HPA:	206	AL	1 set	3 # 230	1 # 250	1 # 4	1
F 8 37	HPB	276	AL	1 set	3 # 250	1 # 750	1 # 4	- 3
-	- 6	-	- 4		F.1	(a)		- 57

GENERAL NOTES:

- WHERE CIRCUIT BREAKER OR FUSES ARE SERIES CONNECTED WHERE CHACUIT HERAPIR OF FISES AND SENIES CONNECTED RATED, THE ENGLOSURE FOR THE OVERCURRENT DEVICES SHALL BE CLEARLY AND LEGIBLY MARKED IN THE FIELD TO INDICATE THE COUPMENT HAS BEEN APPLIED WITH A SERIES COMBINATION RATING. THE MARKING SHALL BE READLY WISIDLE AND READ THE FOLLOWING: CONTION—SERIES COMBINATION. SYSTEM RATED --- AMPERES, IDENTIFIED REPLACEMENT COMPONENTS REQUIRED.
- 2. THE CONTRACTOR SHALL COORDINATE WITH LOCAL UTILITY COMPANY REGARDING SERVICE LATERALS TO METER CENTERS, IF THE LOCAL UTILITY COMPANY WILL NOT PROVIDE ANY SERVICE LATERALS, IT IS THE CONTRACTORS RESPONSIBILITY TO PROVIDE SAID CONDUCTORS AND CONDUIT SIZED PER N.E.C. COORDINATE SERVICE RUNS PRIOR TO SUBMITTING BID.
- 3. PROVIDE PLAQUE NOTED LOCATION OF OTHER METER GROUPS AND SERVICES IN BUILDING.
- 4. THE CONTRACTOR SHALL COORDINATE METER CENTER AND RANSFORMER LOCATIONS WITH LOCAL UTILITY COMPANY AND DEVELOPER.

KEY NOTES:

- MCB METER CENTER SIZE AS NOTED, IOOKAIC RATED.
- $\ensuremath{\langle 1A \rangle}$ who meter center size as noted, 100kaic rated.
- 2) UNIT SUBMETERS WITH INTEGRAL BREAKERS, BREAKERS SHALL BE SERIES RAIED WITH MAIN. SEE LIVING UNIT FEEDER SCHEDULE FOR FEEDER AND BREAKER SIZE.
- (3) ESTIMATED-CENTER OF TOP METER SHALL NOT EXCEED 5"-6" ABOVE GRADE. CENTER OF BOTTOM METER SHALL NOT BE LOWER THAN 30" ABOVE GRADE. COORDINATE WITH UTILITY COMPANY PRIOR TO PURCHASE OR INSTALLATION
- CONDUITS, CONDUCTORS AND CROUNDS, SEE SCHEDULES FOR SIZING.
- 5 200AMP, 3-PHASE FULLY RATED METER FOR HOUSE PANEL ROUTE 4#250KCMIL, 1#4(G)-3°C
- 7 400AMP, 80% RATED (320AMP) METER SOCKET WITH 300AMP CB FOR HOUSE PANEL ROUTE 4#500KCML, 1#2(G)-4"C

NILES BOLTON ASSOCIATES

PROJECT #: 113070.00

DRAWN BY: ####OF

снескей ву: ###cker

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GAINESVILLE address


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INNOVATION SQUARE

SHEET TITLE ELECTRICAL ONELINE DIAGRAM

Project Number - 161-0064 Drawn By: XXX Checked By: XXX

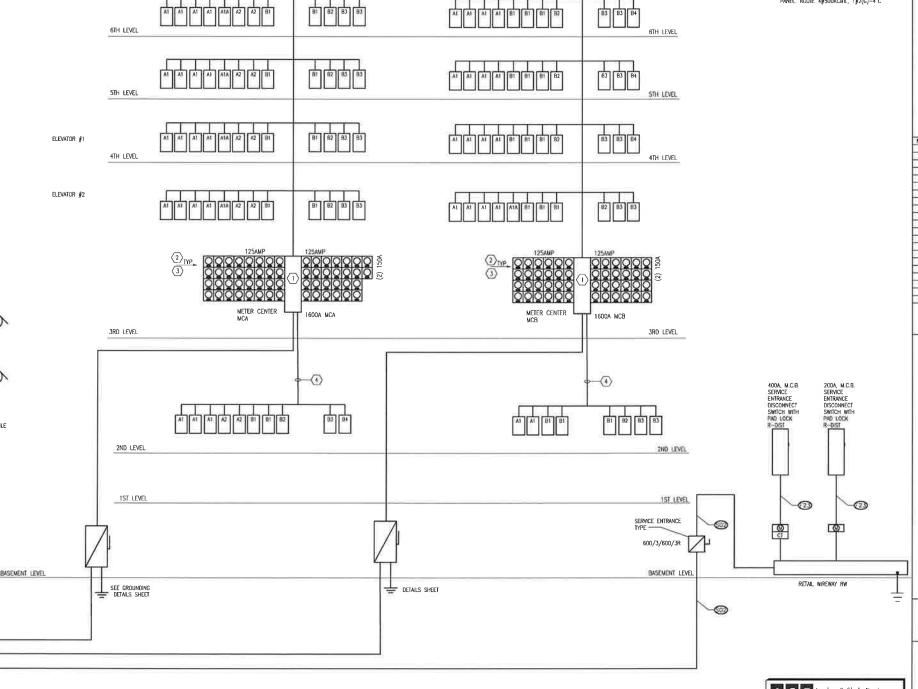02/26/16



PAD MTD. 208V, 36 XFMR

COORDINATE WITH CA POWER AND PROVIDE UTILITY PULL BOX FOR TRANSFORMERS THAT HAVE MORE THEN (12) SETS OF 750KCMIL OR (15) SETS OF 600KCMIL OR LESS OF SERVICE ENTRANCE CONDUCTORS

PAD MTD 208V, 34 XFMR

BUILDING 3 RISER DIAGRAM

I—METER CENTER CONFIGURATIONS SHOWN ON THE RISER DIAGRAMS ARE DIAGRAMATIC ONLY AN ARE SHOWN FOR DESIGN MITCH. SEE ELECTRICAL ROOM PLANS FOR ALL METER CENTER CONFIGURATIONS WICKLOSME ELECTRICAL.

TVSS NOTE

1-PROVIDE DI-TEX 120Y/208 TVSS DILVICES ON ALL FIRE ALBM, SECURITY AND COMMUNICATION CIRCUITS THROUGHOUT THE PROJECT.
2-PROVIDE 60KA PER MODE TVSS DEVICE FOR ALL ELEVATOR FEEDERS.

MULTIPLE SERVICE PLAQUING NOTES

BUILDING WITH MULTIPLE SERVICES PERMANENT PLAQUES WITH IDENTIFICATION MUST BE PROVIDED PER NEC 230,2 (E) AND 225,37

SHORT CIRCUIT CALULATION NOTES

- PRIOR TO ORDERING ELECTRICAL GEAR, CONTRACTOR SHALL CONFIRM ACTUAL SHORT CIRCUIT AWAILABLE AMPS WITH THE EXACT TRANSFORMER SIZE THE UTILITY COMPANY IS FURNISHING.
 AIC RATINGS SHOWN ARE ESTIMATED AND BASED ON A 1,500KVA TRANSFORMER WITH 81,000 SHORT CIRCUIT AMPS AWAILABLE.
- © ESTIMATED MAXIMUM OF 81,000 SHORT CIRCUIT AMPS AT THE TRANSFORMER, 10K A/C BREAKERS IN THE APARTMENT LOAD CENTERS SHALL COORDINATE WITH THE 22KML METER CIRCUIT BREAKERS WHICH WILL COORDINATE WITH THE 100K A/C SWITCHBOARD BREAKERS.
- © ESTIMATED MAXIMUM OF 81,000 SHORT CIRCUIT AMPS AT THE TRANSFORMER, 22K/42K AIC BREAKERS IN THE PANELBOARDS SHALL COORDINATE WITH THE 65K/100K AIC BREAKERS IN THE DISTERIBUTION PANELS AND THE SERVICE SWITCHEODORDS BREAKERS,

SERIES RATED GEAR NOTES

 ALL ELECTRICAL GEAR SHALL BE SERIES RATED, CONTRACTOR SHALL SUBMIT ALL REQUIRED SERIES RATING SIGNAGE AND SUPPORTING SERIES MANUFACTURER'S DOCUMENTATION TO MEET ALL REQUIREMENTS OF NEC 110,10, 110,22 (B) AND (C) AND NEC 240,86 TO THE ELECTRICAL ENGINEER

METER STACK COORDINATION NOTES

ONTE: RISER DIAGRAM STACKING IS DIAGRAMMATIC ONLY AND IS SHOWN FOR NUMBER OF STACKS AND STACK AMPERAGE. CONTRACTOR SHALL PROVIDE STACKS AS SHOWN ON ELECTRICAL ROOM PLAN LAYOUTS. CONTRACTOR SHALL BALANCE THE LOAD ON BOTH THE RIGHT SIDE AND THE LEFT SIDE OF THE METER GROUP

ALL SERVICES SHALL BE SERIES RATED

- PRIOR TO FINAL ORDERING OF PANELBOARDS, CIRCUIT BREAMERS, AND ALL ASSOCIATED EQUIPMENT, THE CONTRACTOR SHALL ARRANGE FOR AND PROVIDE TO THE ELECTRICAL ENGINEER OF RECORD VIA THE ARCHITECT A LETTER FROM THE LOCAL POWER COMPANY ON THEIR LETTERING STATING HIS SHORT CIRCUIT FAULT CURRENT AVALABLE AT THE SECONDARY OF THE UTILITY COMPANY TRANSFORMER. INFORMATION SHALL BE USED TO DETERMINE HE FINAL ALC. RATINGS OF THE PANELBOARDS, METER CENTERS, MAIN DISCONNECT SWITCHES AND CIRCUIT BREAKERS.
- ESTIMATED 72,000 AVAILABLE SHORT CIRCUIT AMPS— VERIFY PRIOR TO ORDERING GEAR, THE 10 KAIC BREAKERS IN THE LOAD CENTERS, 2274AC IN THE HOUSE PANELS AND THE 42XAIC BREAKERS AT THE METERS SHALL BE SERIES RATED WITH THE 100ACK SERVICE MAIN BEAKER FOR INDIACY PROTECTION DOWNSTREAM FROM THE SERVICE MAIN, ALL GEAR SHALL BE ULL LABELED AND LISTED FOR THIS PURPOSE,
- CONTRACTOR SHALL BOND ALL SERVICE GROUNDS TOGETHER.

GENERAL NOTES:

- WHERE CIRCUIT BREAKER OR FUSES ARE SERIES CONNECTED RATED, THE ENCLOSURE FOR THE OVERCURRENT DEVICES SHALL BE CLEARLY AND LEGISLY MARKED IN THE FIELD TO INDICATE THE EQUIPMENT HAS BEEN APPLED WITH A SERIES COMBINATION RAING, THE MARKING SHALL BE FRADILY VISILE AND READ THE FOLLOWING: CAUTION-SERIES COMBINATION OF THE POLLOWING: CAUTION-SERIES COMBINATION OF THE POLLOWING: CAUTION-SERIES COMBINATION OF THE POLLOWING: CAUTION-SERIES COMBINATION CAUTION-SERIES COMBINATION OF THE POLLOWING: CAUTION-SERIES COMBINATION OF THE POLLOWING: CAUTION-SERIES COMBINATION OF THE POLLOWING: CAUTION-SERIES COMBINATION OF THE POLLOWING CAUTION-SERIES COMBINATION OF THE POLLOWING CAUTION-SERIES COMBINATION OF THE POLLOWING CAUTION-SERIES COMBINATION OF THE POLICY OF SYSTEM RATED --- AMPERES IDENTIFIED REPLACEMENT COMPONENTS REQUIRED.
- THE CONTRACTOR SHALL COORDINATE WITH LOCAL UTILITY OMPANY REGARDING SERVICE LATERALS TO METER CENTERS.

 IF THE LOCAL UTILITY COMPANY WILL NOT PROVIDE ANY
 SERVICE LATERALS, IT IS THE CONTRACTORS RESPONSIBILITY TO
 PROVIDE SAUD CONDUCTORS AND CONDUIT SIZED FER N.E.C.

 SETWATER OF TOP METER SHALL
 NOT EXCERD 5"-6"* ABOVE GRADE.

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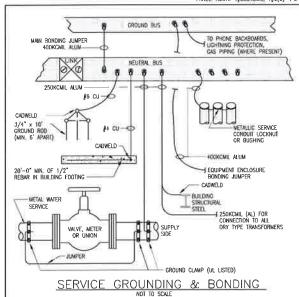
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- PROVIDE PLAQUE NOTED LOCATION OF OTHER METER GROUPS
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KEY NOTES:

- MCB METER CENTER SIZE AS NOTED, 100KAC PATED.
- (1A) MLO METER CENTER SIZE AS NOTED, 100KAIC RATED.
- (2) UNIT SUBMETERS WITH INTEGRAL BREAKERS, BREAKERS SHALL BE SERIES RATED WITH MAIN. SEE LIVING UNIT FEEDER SCHEDULE FOR FEEDER AND BREAKER SIZE,
- NOT EXCEED 5'-6"* ABOVE GRADE CENTER OF BOTTOM METER SHALL NOT BE LOWER THAN 30" ABOVE GRADE COORDINATE WITH UTILITY COMPANY PRIOR TO PURCHASE OR INSTALLATION
- CONDUITS, CONDUCTORS AND GROUNDS.
 SEE SCHEDULES FOR SIZING.
- 6 225AMP, 3-PHASE FULLY RATED METER FOR HOUSE PANEL ROUTE 4 100KCMIL, 1#2(G)-3°C
- 7 400AMP, 80% RATEO (320AMP) METER SOCKET WITH 300AMP CB FOR HOUSE PANEL ROUTE 4#550KCML 1#2(G)-4°C



SERVICE EQUIPMENT "CDP GROUND BUS 6 8 MAIN BONDING JUMPER 250KCMIL ALUM ROUTE GROUNDING ELECTRODE TO SERVICE EQUIPMENT "NC3"
250KCMIL ALUM 250KCMI, ALUM SOURCE BONDING JUMPER SERVICE GROUNDING & BONDING
NOT TO SCALE

> Jordan & Skala Engineers
>
> 1275 Sinc Behold Rated, Since 457
> Necture CA 30001 Project Number - 161-0064 Drawn By: XXX Checked By: XXX

PROJECT #: 113070.00 DRAWN BY: Author CHECKED BY: Checker

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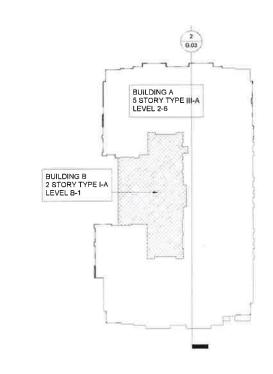
GAINESVILLE SQUARE ē

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SHEET TITLE LEGENDS, NOTES. DETAILS, SCHEDULES - 2 ELECTRICAL

INNOVATION

E0.04



DRAWNBY: Author Checker Checker

PROJECT#: 113070.00

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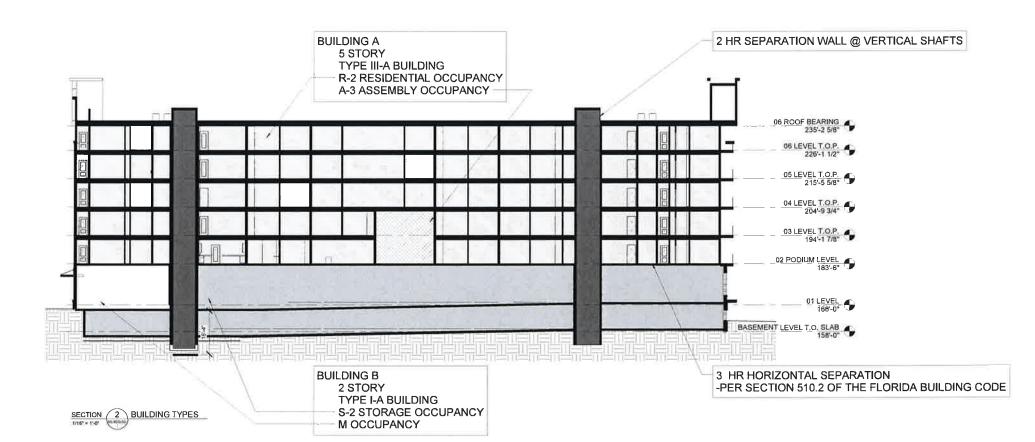
INNOVATION SQUARE - GAINESVILLE

Benoit Group

SHEETTINE CODE ANALYSIS

SHEETNUMBER

G.03





FIRE RESISTANCE RATINGS SEE LIFE SAFETY PLANS, PARTITION TYPES & UL ASSEMBLIES

ASSEMBLY RATINGS	REQUIRED HOURLY @ TYPE III-A BUILDING	DESIGN NO. FOR RATED ASSEMBLIES	REQUIRED HOURLY @ TYPE 1-A BUILDING	DESIGN NO. FOR RATED ASSEMBLIES
STRUCTURAL FRAME	1 HOUR (FBC TABLE 601)	N/A	3 HOUR (FBC TABLE 601)	SEE TABLES FROM FBC 2014 ON SHEET A0,20
EXTERIOR WALLS LOAD-BEARING	1 HOUR (FBC TABLE 601)	UL U356	3 HOUR (FBC TABLE 601	UL U425
INTERIOR WALLS LOAD-BEARING	1 HOUR (FBC TABLE 601)	UL U309	3 HOUR (FBC TABLE 601)	N/A
EXTERIOR WALLS NON-LOAD BEARING	1 HOUR (FBC TABLE 602)	UL U356	I HOUR (FBC TABLE 602)	UL U425
INTERIOR WALLS NON-LOAD BEARING	0 HOUR (FBC TABLE 601)	N/A	0 HOUR (FBC TABLE 601)	N/A
TYPICAL FLOOR CONSTRUCTION	1 HOUR (FBC TABLE 501)	UL L521	2 HOUR (FBC TABLE 601)	SEE TABLES FROM FBC 2014 ON SHEET A0,20
OCCUPANCY SEPARATION (FIRE BARRIERS)	1 HOUR (FBC TABLE 508.4)	UL U419	1 HOUR (FBC TABLE 508,4)	UL U419
BUILDING SEPARATION (FIRE WALLS)	3 HOUR (FBC TABLE 706,4)	N/A	3 HOUR (FBC TABLE 706,4)	N/A
ROOF CONSTRUCTION (INCLUDING SUPPORTING BEAMS & JOIST	1 HOUR (FBC TABLE 601)	UL P522	1 1/2 HOUR (FBC TQABLE 601)	N/A
ROOF COVERING CLASSIFICATION	CLASS B (FBC TABLE 1505,1)			
VERTICAL EXIT ENCLOSURES	2 HOUR (NFPA 101 SECT_8,6,5)	UL U905		
SHAFT ENCLOSURES	2 HOUR (FBC SECT_713_4 - ALSO SEE (UL U905 GA AMENDMENTSJUL 4438		

EXTERIOR WALLS SHALL BE FIRE-RESISTANCE RATED IN ACCORDANCE WITH TABLES 601 & 602 AND THIS SECTION. THE REQUIRED FIRE-RESISTANCE RATING OF EXTERIOR WALLS WITH A FIRE SEPARATION DISTANCE OF GREATER THAN 10 FEET SHALL BE RATED FOR EXPOSURE TO FIRE FROM THE INSIDE, THE REQUIRED FIRE-RESISTANCE RATING OF EXTERIOR WALLS WITH A FIRE SEPARATION DISTANCE OF LESS THAN OR EQUAL TO 10 FEET SHALL BE RATED FOR EXPOSURE TO FIRE FROM BOTH SIDES (FBC 708.5)

BUILDING AREA	(PER FLORIDA BUILI	DING CODE)	BUILDING AREA	(PER FLORIDA BUII	DING CODE)
Level	Name	Area	Lovel	Name	Area
ASEMENT LEVEL	F.O. SLAB		05 LEVEL T.O.P.	RESIDENTIAL	20564 SF
ASEMENT LEVEL	CIRCULATION	152 SF	05 LEVEL T.O.P.	SERVICE	657 SF
O. SLAB			05 LEVEL T.O.P.	STAIRWELL	440 SF
ASEMENT LEVEL	PARKING LEVEL	28314 SF	05 LEVEL T.O.P.	STORAGE	365 SF
O SLAB					26645 SF
ASEMENT LEVEL	SERVICE	1782 SF	OF LEVEL T.O.P.		
O, SLAB			OG LEVEL T.Q.P.	BALCONY	1084 SF
ASEMENT LEVEL	STAIRWELL	573 SF	DE LEVEL T.O.P.	CIRCULATION	3425 SF
ASEMENT LEVEL	STORAGE	1550 SF	OF LEVEL T.O.P.	RESIDENTIAL	20685 SF
O. SLAB	atororac	1300 ar	DS LEVEL T.O.P.	SERVICE	657 SF
130.9090.90		32370 SF	06 LEVEL T.O.P.	STAIRWELL	440 SF
1 LEVEL			06 LEVEL T.O.P.	STORAGE	365 SF
LEVEL	CIRCULATION	963 SF			26657 SF
LEVEL	PARKING LEVEL	24652 SF			197446 SF
LEVEL	RETAIL	3879 SF			
LEVEL	SERVICE	1009 SF			
LEVEL	STAIRWELL	573 SF			

3765 SF 768 SF 3436 SF 1506 SF 16017 SF 313 SF 433 SF 199 SF 26437 SF

STORAGE

	DEVELOPMEN	R GAINESVILLE LAND T CODE)
AMENITIES	3765 SF	2%
CIRCULATION	18252 SF	9%
LEASING	1505 SF	1%
PARKING LEVEL	52966 SF	28%
RESIDENTIAL	98131 SF	51%
RETAIL	3879 SF	2%
SERVICE	5734 SF	3%
STAIRWELL	3339 SF	2%
STORAGE	4744 SF	2%
Grand total	192314 SF	

BASEMENT	
PARKING SPACE (9'X18')	67
PARKING SPACE (12X18)	
BIKE SPACE	0
SCOOTER SPACE	21
LEVEL 01	93
PARKING SPACE (FX18)	54
PARKING SPACE (12'X18')	- 4
BIKE SPACE	72
SCOOTER SPACE	7
TOTAL	133
PARKING SPACE (9X18)	121
PARKING SPACE (12X16)	- 5
BIKE SPACE	72
SCOOTER SPACE	28
	000

PARKING

COUNT

				UN	IITS PER LEV	EL.							
BEDROOMS	UNIT TYPES	NET SF PER UNIT	LEVEL 2	LEVEL 3	LEVEL 4	LEVEL 5	LEVEL 6	TOTAL UNITS	UNIT MIX	TOTAL BEDS	TOTAL % OF BEDS	TARGET % OF BEDS	TOTAL UNIT SF
	A1	660	7	9	9	9	g	43	25.90%	43			2838
	A1 ALT	658	o	1	0	D	o	1	0.60%	1			65
	A2	824	2	2	2	2	2	10	6.02%	10	31 93%		824
	B1	1045	5	5	5	5	5	25	30.12%	50			2612
	B2	997	1	2	2	2	2	9	10.84%	18			897
	В3	1134	3	4	4	4	4	19	22.89%	38			2154
	B4	1240	o	0	1	1	1	3	3.61%	6	67.47%		372

TOTAL LINUTS TOTAL BEDS PROJECT #: 113070.00 ORAWN BY: Author CHECKED BY: Checker

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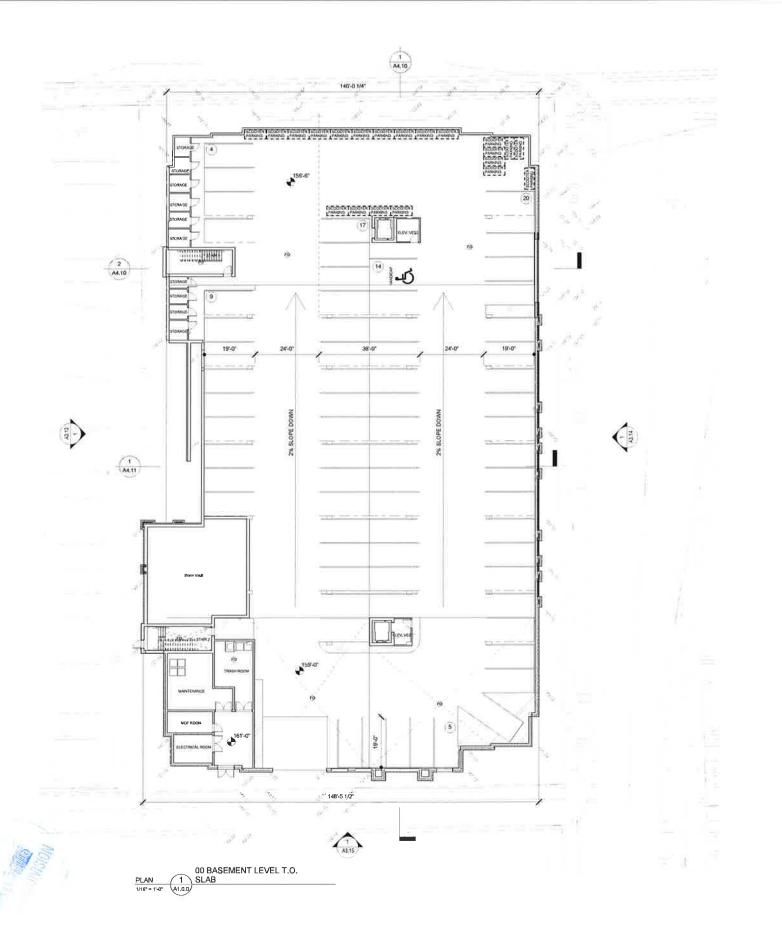
GAINESVILLE

INNOVATION SQUARE -

SHEET TITLE BUILDING INFORMATION

SHEET NUMBER

G.04



2HR CONCRETE BLOCK WALL WOOD STUD WALL

BRICK VENEER

PARTITION TYPE: FOR WOOD FRAMING REFER TO A0,30, FOR CMU FRAMING REFER TO A0.31,

WINDOW TYPE



36" ACCESSIBLE ROUTE



UNITS WITH MOBILITY UNITS WITH COMMUNICATION FEATURES



FIRE EXTINGUISHER CABINET

NOTES:

- REFER TO SHEETS A6.10-A6.22 FOR ALL STAIR AND ELEVATOR INFORMATION ALL DIMENSIONS ARE TO FACE OF STUD OR BLOCK UNLESS NOTED OTHERWISE REFER TO UNIT PLANS FOR UNIT DIMENSIONS DOORS ARE 4" FROM STRUCTURE OR FACE OF GYPSUM BOARD OR CENTERED IN WALL PANEL UNLESS DIMENSIONED OTHERWISE.

 MAX. SLOPE 2% IN ALL DIRECTIONS AT ACCESSIBLE ROUTES AND SPACES EACH UNIT WITH MOBILITY FEATURES MUST HAVE AN ACCESSIBLE MAILBOX OF 48" OR LESS.

 A KNOX BOX WILL BE PROVIDED TO ENSURE EMERGENCY ACCESS TO THE "RESTRICTED ACCESS OCCUPANCY". RESTRICTED ACCESS OCCUPANCY". RESTRICTED ACCESS OCCUPANCY WEANS; ANY MULTIPLE RESIDENTIAL OCCUPANCY WITH INTERIOR CORRIDORS THAT LEAD TO INDIVIDUAL RESIDENTIAL UNITS, TO WHICH GENERAL PUBLIC ACCESS IS DESTRICTED. UNITS, TO WHICH GENERAL PUBLIC
 ACCESS IS RESTRICTED, [GAINESVILLE
 FIRE PREVENTION AND PROTECTION CODE SECTION 10-16 (b)]

PROJECT #: 113070.00 DRAWN BY: Author

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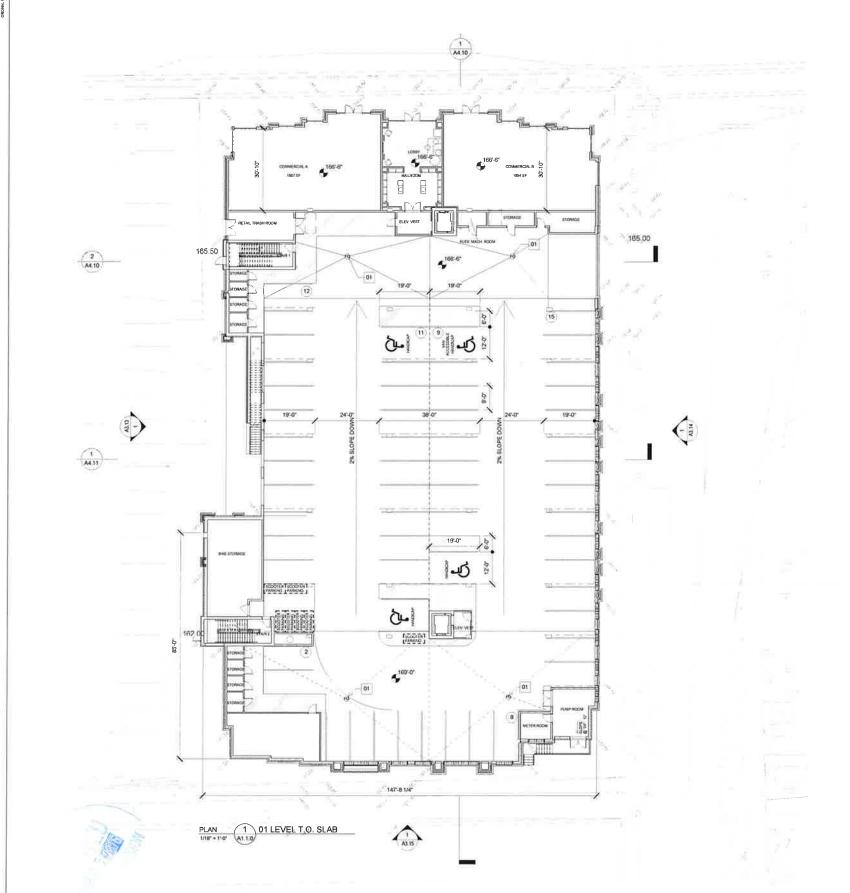
INNOVATION SQUARE - GAINESVILLE

Benoit Group

SHEET TITLE BASEMENT FLOOR PLAN

SHEET NUMBER

A1.0.0



2HR CONCRETE BLOCK WALL

WOOD STUD WALL BRICK VENEER

<u>101</u>

PARTITION TYPE: FOR WOOD FRAMING REFER TO A0 30 FOR CMU FRAMING REFER TO A0 31

DOOR NUMBER

11

WINDOW TYPE

36" ACCESSIBLE ROUTE UNITS WITH MOBILITY FEATURES

Ġ

UNITS WITH COMMUNICATION FEATURES

FIRE EXTINGUISHER CABINET

NOTES:

- REFER TO SHEETS A6, 10-A6, 22 FOR ALL STAIR AND ELEVATOR INFORMATION ALL DIMENSIONS ARE TO FACE OF STUD OR BLOCK UNLESS NOTED OTHERWISE REFER TO UNIT PLANS FOR UNIT DIMENSIONS DOORS ARE 4" FROM STRUCTURE OR FACE OF GYPSUM BOARD OR CENTERED IN WALL PANEL UNLESS DIMENSIONED OTHERWISE.

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 A KNOX BOX WILL BE PROVIDED TO ENSURE EMERGENCY ACCESS TO THE "RESTRICTED ACCESS OCCUPANCY". RESTRICTED ACCESS OCCUPANCY MEANS, ANY MULTIPLE RESIDENTIAL OCCUPANCY WILL MITHING TO CORRIDORS THAT LEAD TO INDIVIDUAL RESIDENTIAL UNITS, TO WHICH GENERAL PUBLIC ACCESS IS RESTRICTED, [GAINESVILLE FIRE PREVENTION AND PROTECTION CODE SECTION 10-16 (b)]

PROJECT#: 113070.00 DRAWN BY: Author CHECKED BY: Checker

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ASSOCIATES

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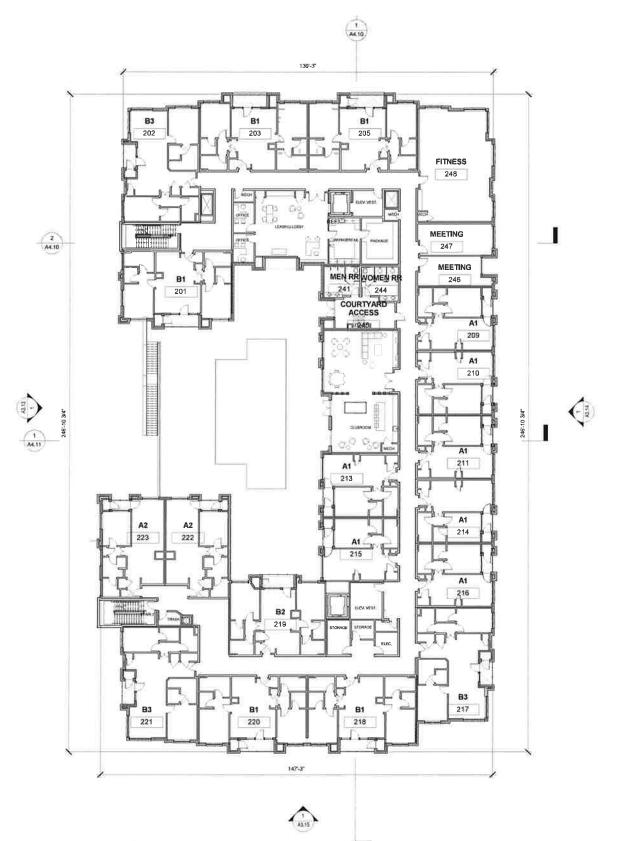
INNOVATION SQUARE - GAINESVILLE

Benoit Group

SHEET TITLE FIRST FLOOR PLAN

SHEET NUMBER

A1.1.0



1 1 1 1

2HR CONCRETE BLOCK WALL WOOD STUD WALL

BRICK VENEER

PARTITION TYPE: FOR WOOD FRAMING REFER TO A0.30. FOR CMU FRAMING REFER TO A0.31. DOOR NUMBER

(1t)

WINDOW TYPE

36" ACCESSIBLE ROUTE

UNITS WITH COMMUNICATION FEATURES

UNITS WITH MOBILITY FEATURES

FIRE EXTINGUISHER CABINET

NOTES:

REFER TO SHEETS A6,10-A6,22 FOR ALL STAIR AND ELEVATOR INFORMATION ALL DIMENSIONS ARE TO FACE OF STUD OR BLOCK UNLESS NOTED OTHERWISE REFER TO UNIT PLANS FOR UNIT DIMENSIONS DOORS ARE 4" FROM STRUCTURE OR FACE OF GYPSUM BOARD OR CENTERED IN WALL PANEL UNLESS DIMENSIONED OTHERWISE.

IN WALL PANEL UNLESS DIMENSIONED OTHERWISE.

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ACCESS IS RESTRICTED, [GAINESVILLE
FIRE PREVENTION AND PROTECTION CODE
SECTION 10-16 (b)] PROJECT #: 113070.00 DRAWN BY: Author

CHECKED BY: Checker

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INNOVATION SQUARE - GAINESVILLE

Benoit Group

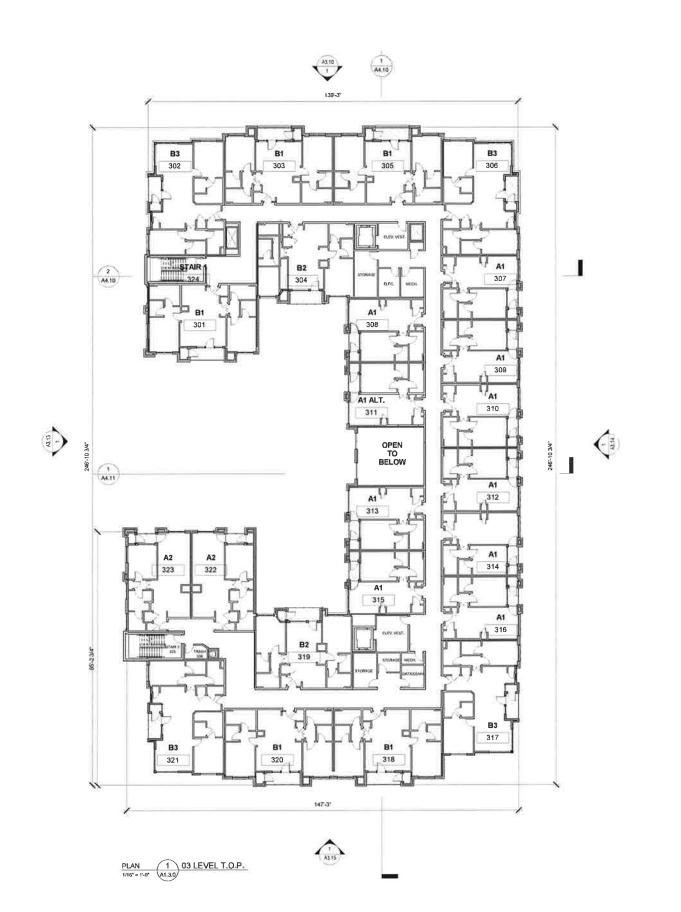
SHEET TITLE SECOND FLOOR PLAN

SHEET NUMBER

A1.2.0

2/26/16

PLAN 11/6" = 1'-0" 02 PODIUM T.O. SLAB



2HR CONCRETE BLOCK WALL

WOOD STUD WALL

BRICK VENEER

PARTITION TYPE: FOR WOOD FRAMING REFER TO A0.30, FOR CMU FRAMING REFER TO A0.31, DOOR NUMBER

WINDOW TYPE



36" ACCESSIBLE ROUTE



UNITS WITH MOBILITY



UNITS WITH COMMUNICATION FEATURES FIRE EXTINGUISHER CABINET

NOTES:

- REFER TO SHEETS A6,10-A6,22 FOR ALL STAIR AND ELEVATOR INFORMATION ALL DIMENSIONS ARE TO FACE OF STUD OR BLOCK UNLESS NOTED OTHERWISE
- OR BLOCK UNLESS NOTED OTHERWISE REFER TO UNIT PLANS FOR UNIT DIMENSIONS DOORS ARE 4" FROM STRUCTURE OR FACE OF GYPSUM BOARD OR CENTERED IN WALL PANEL UNLESS DIMENSIONED OTHERWISE. MAX, SLOPE 2% IN ALL DIRECTIONS AT ACCESSIBLE ROUTES AND SPACES EACH UNIT WITH MOBILITY FEATURES MUST HAVE AN ACCESSIBLE MAILBOX OF 48" OR LESS. A KNOX BOX WILL BE PROVIDED TO ENSURE EMERGENCY ACCESS TO THE

- A KNOX BOX WILL BE PROVIDED TO ENSURE EMERGENCY ACCESS TO THE "RESTRICTED ACCESS OCCUPANCY", RESTRICTED ACCESS OCCUPANCY MEANS; ANY MULTIPLE RESIDENTIAL OCCUPANCY WITH INTERIOR CORRIDORS THAT LEAD TO INDIVIDUAL RESIDENTIAL UNITS, TO WHICH GENERAL PUBLIC
 ACCESS IS RESTRICTED, [GAINESVILLE
 FIRE PREVENTION AND PROTECTION CODE SECTION 10-16 (b)]

PROJECT #: 113070.00 DRAWN BY: Author

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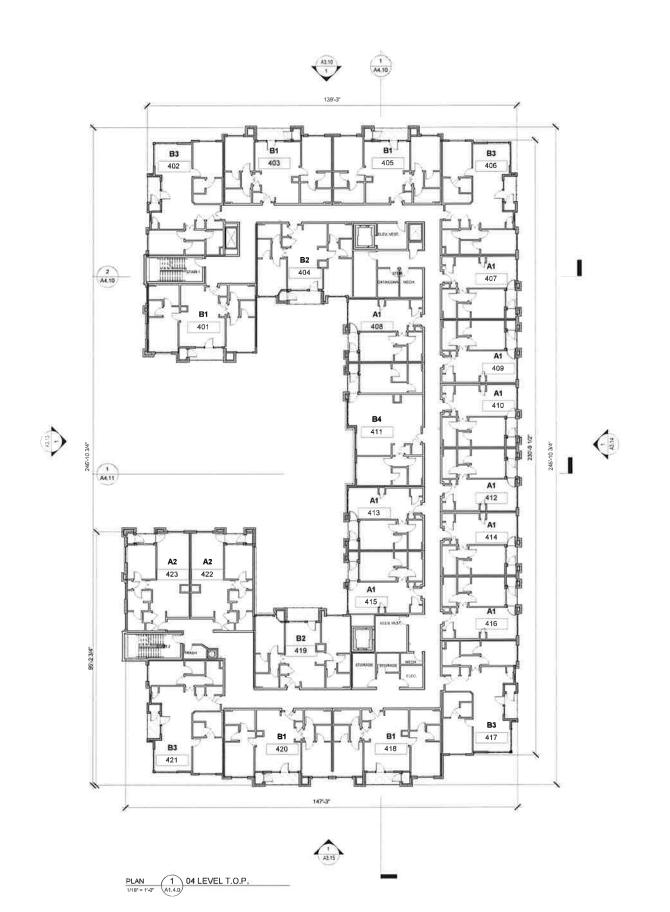
INNOVATION SQUARE - GAINESVILLE

Benoit Group

SHEET TITLE THIRD FLOOR PLAN

SHEET NUMBER

A1.3.0



LEGEND

2HR CONCRETE BLOCK WALL

WOOD STUD WALL

BRICK VENEER

PARTITION TYPE: FOR WOOD FRAMING REFER TO A0.30. FOR CMU FRAMING REFER TO A0.31. DOOR NUMBER

WINDOW TYPE

36" ACCESSIBLE ROUTE



UNITS WITH MOBILITY FEATURES

UNITS WITH COMMUNICATION FEATURES FIRE EXTINGUISHER CABINET

NOTES:

REFER TO SHEETS A6,10-A6,22 FOR ALL STAIR AND ELEVATOR INFORMATION ALL DIMENSIONS ARE TO FACE OF STUD OR BLOCK UNLESS NOTED OTHERWISE REFER TO UNIT PLANS FOR UNIT DIMENSIONS DOORS ARE 4" FROM STRUCTURE OR FACE OF GYPSUM BOARD OR CENTERED IN WALL PANEL UNLESS DIMENSIONS OTHERWISE.

MAX. SLOPE 2% IN ALL DIRECTIONS AT ACCESSIBLE ROUTES AND SPACES EACH UNIT WITH MOBILITY FEATURES MUST HAVE AN ACCESSIBLE MAILBOX OF 48" OR LESS.

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PROJECT #: 113070.00

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INNOVATION SQUARE - GAINESVILLE


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The Benoit Group

SHEET TITLE FOURTH FLOOR PLAN

SHEET NUMBER

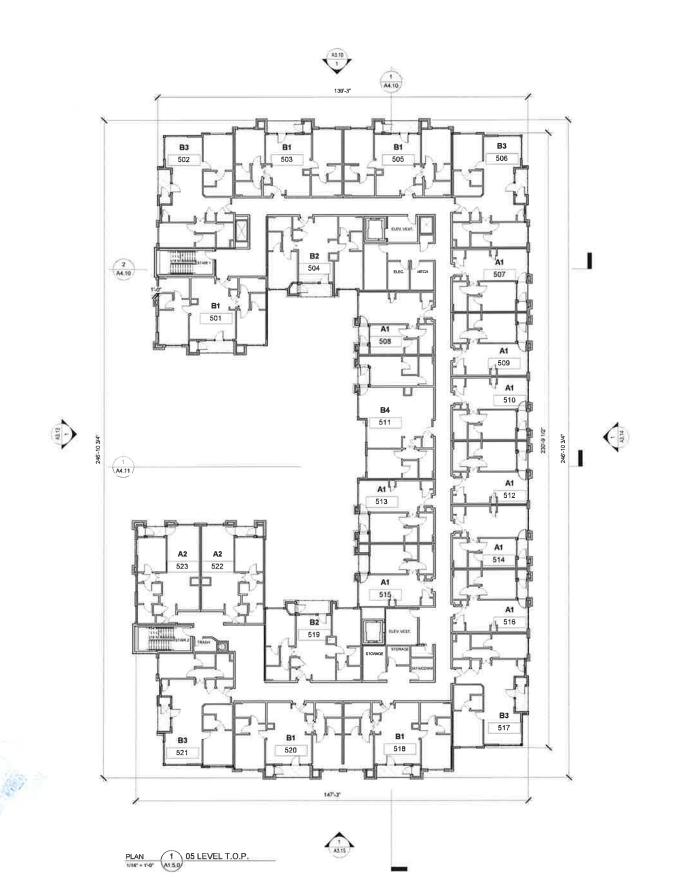A1.4.0



LEGEND 1 A 2 A

2HR CONCRETE BLOCK WALL WOOD STUD WALL

BRICK VENEER

PARTITION TYPE: FOR WOOD FRAMING REFER TO A0,30, FOR CMU FRAMING REFER TO A0,31, DOOR NUMBER

WINDOW TYPE

(11)

36" ACCESSIBLE ROUTE

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UNITS WITH MOBILITY FEATURES

UNITS WITH COMMUNICATION FEATURES

FIRE EXTINGUISHER CABINET

NOTES:

- REFER TO SHEETS A6, 10-A6, 22 FOR ALL STAIR AND ELEVATOR INFORMATION ALL DIMENSIONS ARE TO FACE OF STUD OR BLOCK UNLESS NOTED OTHERWISE REFER TO UNIT PLANS FOR UNIT

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 UNITS, TO WHICH GENERAL PUBLIC
 ACCESS IS RESTRICTED. [GAINESVILLE
 FIRE PREVENTION AND PROTECTION CODE
 SECTION 10-16 (b)]

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INNOVATION SQUARE - GAINESVILLE

Benoit Group

SHEET TITLE FIFTH FLOOR PLAN

SHEET NUMBER

A1.5.0



LEGEND

2HR CONCRETE BLOCK WALL

WOOD STUD WALL BRICK VENEER

PARTITION TYPE: FOR WOOD FRAMING REFER TO A0,30, FOR CMU FRAMING REFER TO A0,31,

DOOR NUMBER 11)

WINDOW TYPE

36" ACCESSIBLE ROUTE



UNITS WITH MOBILITY FEATURES

UNITS WITH COMMUNICATION FEATURES

FIRE EXTINGUISHER CABINET

NOTES:

REFER TO SHEETS A6.10-A6.22 FOR ALL STAIR AND ELEVATOR INFORMATION ALL DIMENSIONS ARE TO FACE OF STUD OR BLOCK UNLESS NOTED OTHERWISE REFER TO UNIT PLANS FOR UNIT

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FIRE PREVENTION AND PROTECTION CODE
SECTION 10-16 (b)] PROJECT #: 113070.00 DRAWN BY: Author CHECKED BY: Checker

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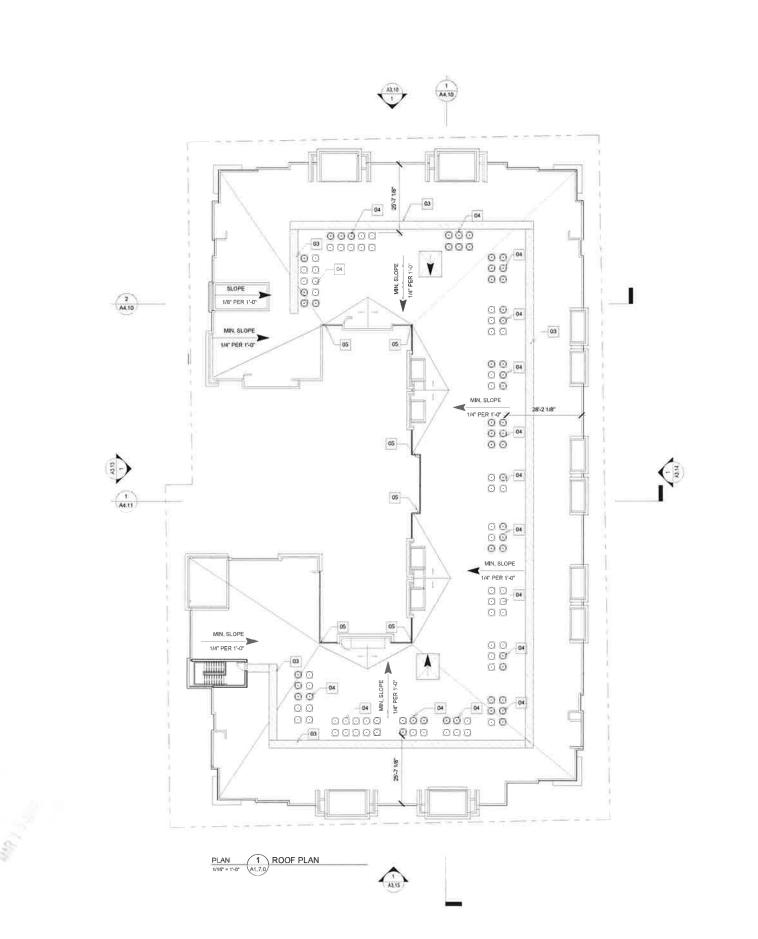
INNOVATION SQUARE - GAINESVILLE

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SHEET TITLE SIXTH FLOOR PLAN

SHEET NUMBER

A1.6.0



LEGEND * * * *

2HR CONCRETE BLOCK WALL WOOD STUD WALL

BRICK VENEER

PARTITION TYPE: FOR WOOD FRAMING REFER TO A0.30, FOR CMU FRAMING REFER TO A0,31,

(101)

DOOR NUMBER WINDOW TYPE

(lt)

36" ACCESSIBLE ROUTE



UNITS WITH MOBILITY FEATURES



UNITS WITH COMMUNICATION FEATURES



FIRE EXTINGUISHER CABINET

NOTES:

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Keynote	Legend
	KEYNOTE

NUMBER	KEYNOTE	
03	TRAFFIC PAD	
04	CONDENSER UNIT - TYP.	
05	DOWNSPOUT & GUTTER	

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INNOVATION SQUARE - GAINESVILLE

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SHEET TITLE ROOF PLAN

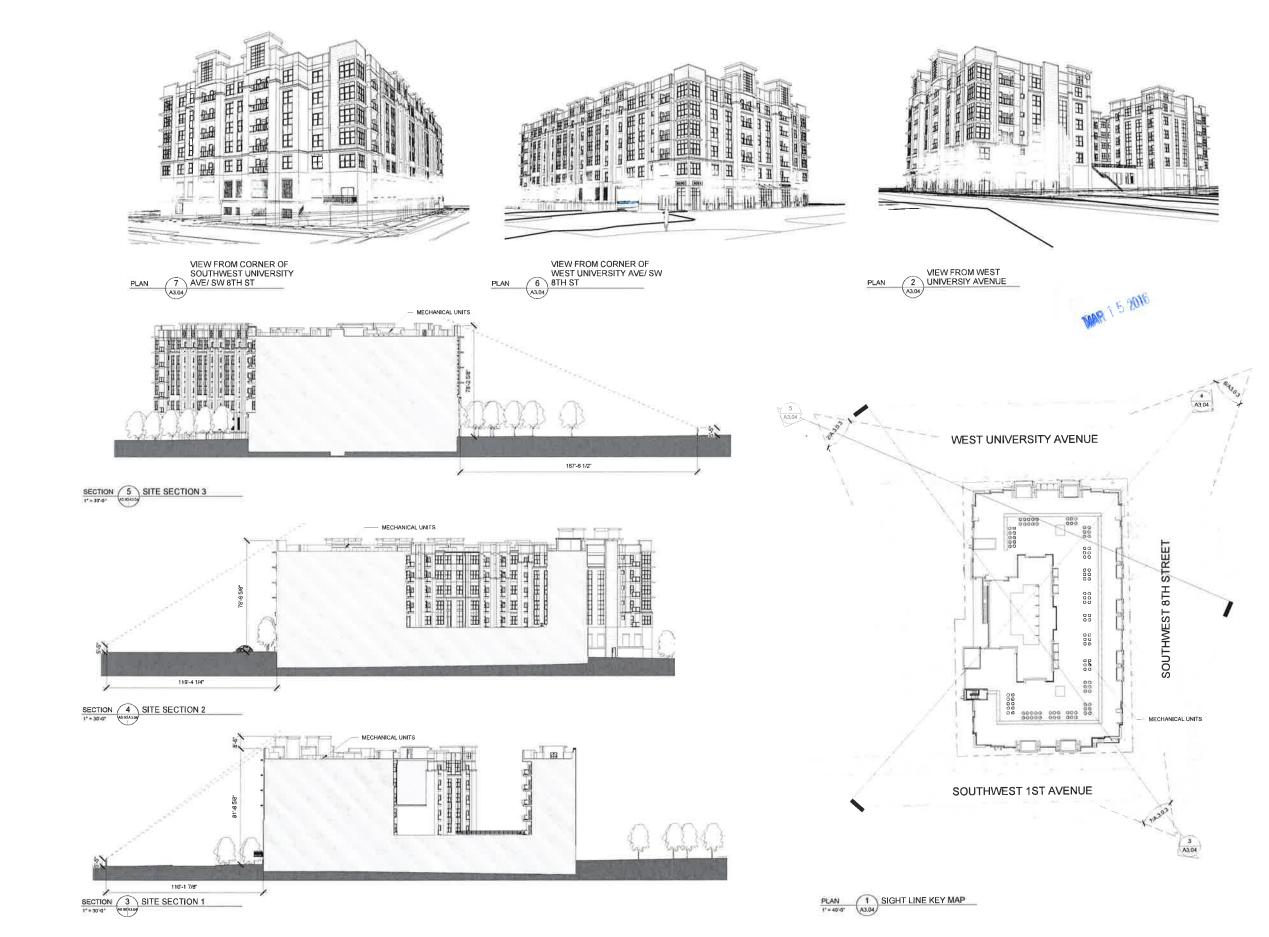
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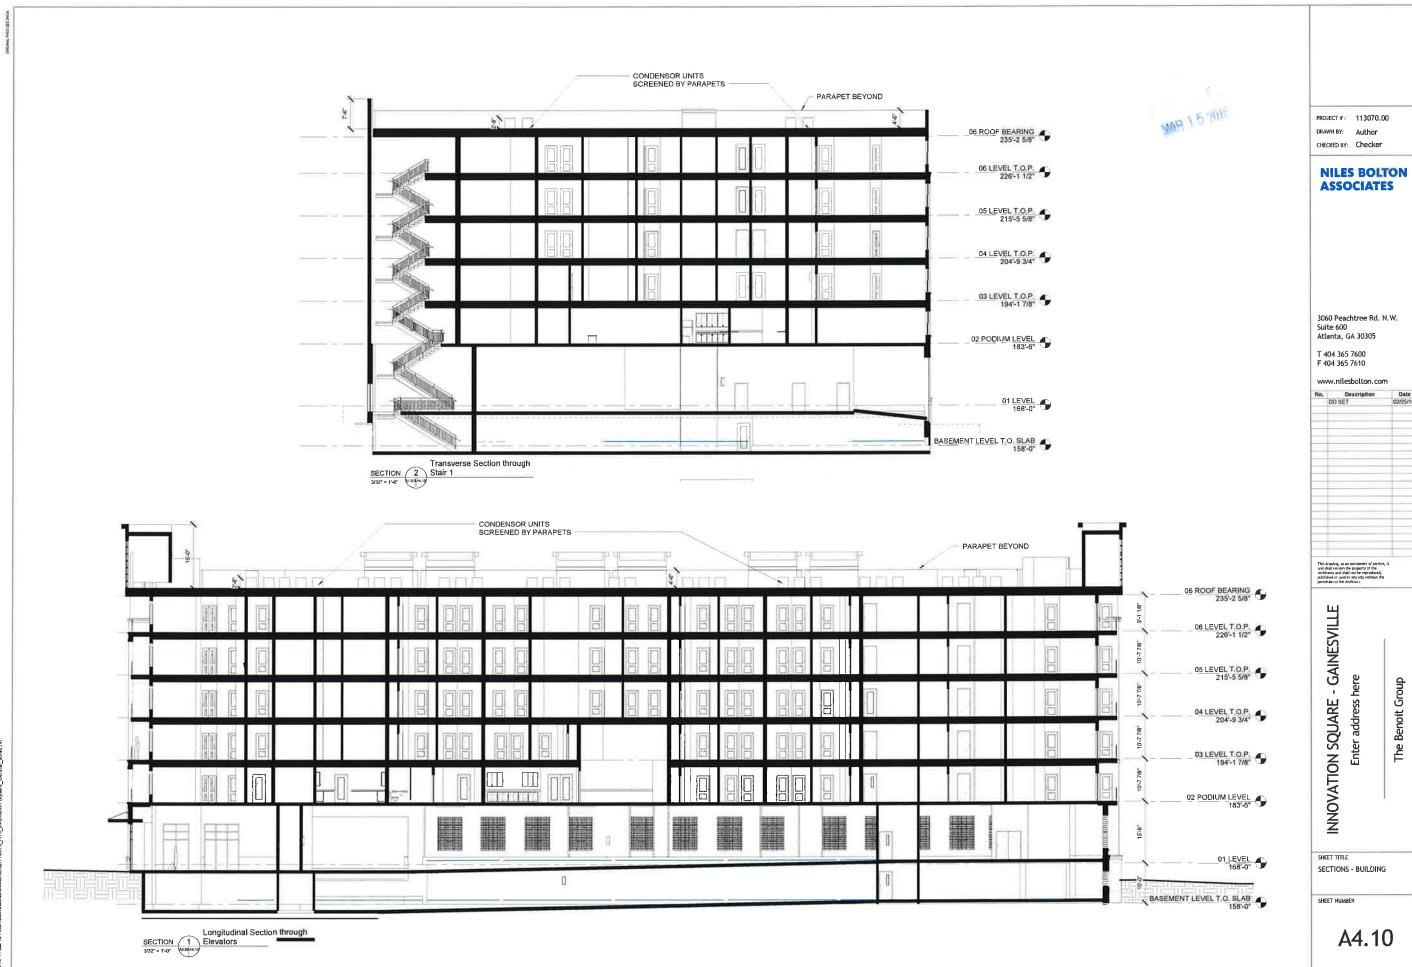
INNOVATION SQUARE - GAINESVILLE

The Benoit Group

SHEET TITLE SIGHT LINES

SHEET NUMBER

A3.04





CONDENSOR UNITS SCREENED BY PARAPET PARAPET BEYOND 06 ROOF BEARING 235'-2 5/8" 06 LEVEL T.O.P. 226'-1 1/2" \mathbb{H} 05 LEVEL T.O.P. 215'-5 5/8" H 04 LEVEL T.O.P. 204'-9 3/4" H 03 <u>LEVEL T.O.P.</u> 194'-1 7/8" H 02 PODIUM LEVEL 183'-6" 01 LEVEL 168'-0" BASEMENT LEVEL T.O. SLAB 158'-0" Transverse Section through
SECTION 1
Pool
3/32" = 1'-0"
LLAGALI)

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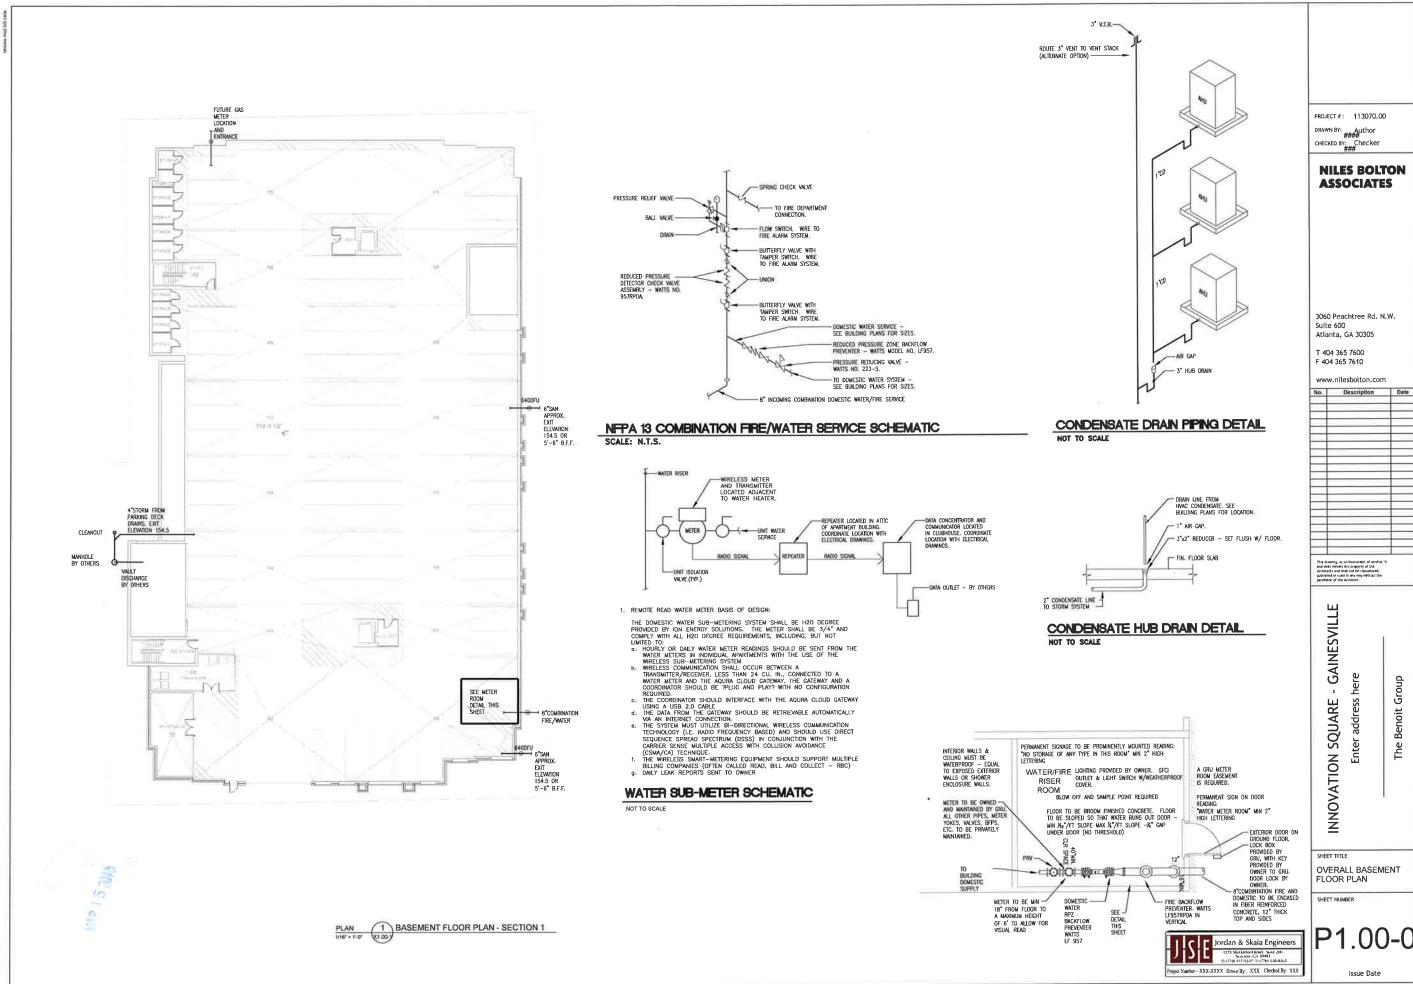
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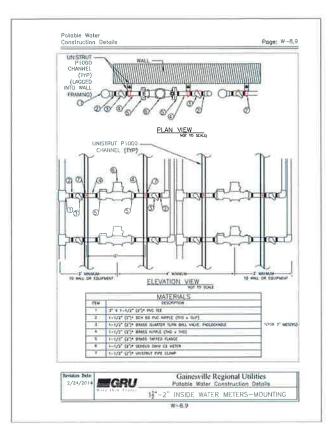
SHEET TITLE SECTIONS - BUILDING

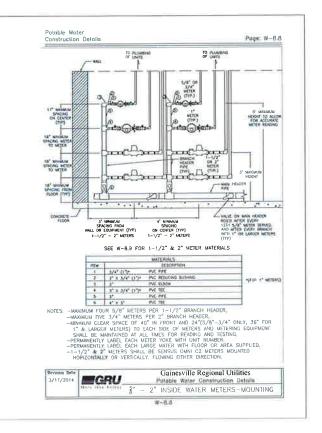
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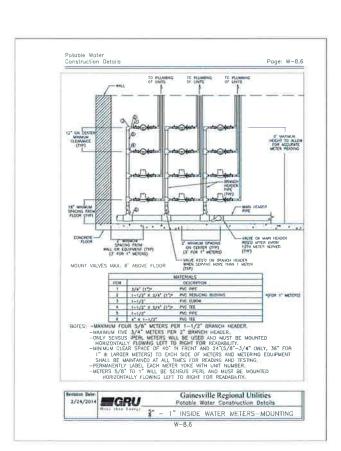
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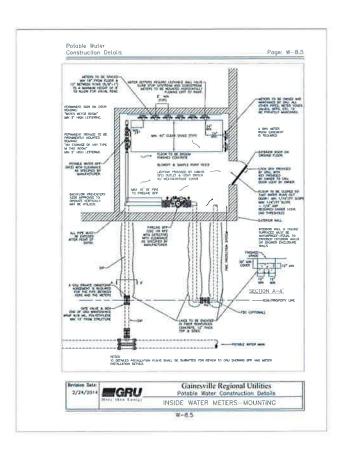


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INNOVATION SQUARE - GAINESVILLE

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Jordan & Skala Engineers

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