GAINESVILLE, FLORIDA

DEVELOPMENT REVIEW PACKAGE

DATE OF ISSUE: 03/01/16

IGAT PARCEL 914200-00-010 & 814209-00-000

(OFFICIAL RECORDS BOOK 1723, PAGE 1542)

ALL OF LOTS 1, 2, AND 5 TOGETHER WITH THE SOUTH 81.55 FEET OF LOTS 3 AND 4 OF THE REPLAT OF THE WEST HALF OF BLOCK-19 OF "BRUSH'S ADDITION TO GAINESVILLE, F.L", FILED JANUARY 24, 1925, IN PLAT BOOK "A", AT PAGE 16 OF THE PUBLIC RECORDS OF ALACHUA COUNTY, FLORIDA, ALSO THE EAST HALF OF BLOCK 19 OF BRUSH'S ADDITION AS PER PLAT THEREOF, AS RECORDED IN DEED BOOK "O", PAGE 218 LESS THE EAST 150 FEET THEREOF, LESS ALL THE RIGHT-OF-WAY FOR N.W. 2ND AVENUE, PER OFFICIAL RECORDS BOOK 733, PAGE 431, ALSO THE WEST 28.070 FEET OF BLOCK 20 OF BRUSH'S ADDITION AS PER PLAT THEREOF, AS RECORDED IN DEED BOOK "O", PAGE 218, OF THE PUBLIC RECORDS OF ALACHUA COUNTY, FLORIDA THAT PART OF SAID BLOCK 19 ABOVE, BEING MORE PARTICULARLY DESCRIBED AS FOLLOWS: FOR A POINT OF BEGINNING, COMMENCE AT A DRILL HOLE MARKING THE SOUTHWEST CORNER OF SAID BLOCK 19, OF "BRUSH'S ADDITION TO GAINESVILLE FLORIDA", SAID POINT ALSO BEING ON THE EASTERLY RIGHT-OF-WAY LINE OF N.W. 38D STREET (A 32 FOOT RIGHT-OF-WAY), THENCE RUN NORTH 01*20*1" WEST, ALONG SAID EASTERLY RIGHT-OF-WAY LINE, RUN NORTH 89*15*22" EAST, A DISTANCE OF 10.4.11 FEET TO A SET REBAR AND CAP STAMPED P.L.S. 2223, "THENCE RUN NORTH 01*220*" WEST, A DISTANCE OF 48.59 FEET TO A CONCRETE MONUMENT, THENCE RUN NORTH 01*220*" WEST, A DISTANCE OF 48.59 FEET TO A CONCRETE MONUMENT, THENCE RUN NORTH 01*220*" WEST, A DISTANCE OF 48.59 FEET TO A CONCRETE MONUMENT, THENCE RUN NORTH 01*220*" WEST, A DISTANCE OF 48.59 FEET TO A CONCRETE MONUMENT, THENCE RUN NORTH 01*220*" WEST, A DISTANCE OF 48.59 FEET TO A CONCRETE MONUMENT, THENCE RUN NORTH 01*220*" WEST, A DISTANCE OF 48.59 FEET TO A CONCRETE MONUMENT, THENCE RUN NORTH 01*220*" WEST, A DISTANCE OF 48.59 FEET TO A CONCRETE MONUMENT, THENCE RUN NORTH 01*220*" WEST, A DISTANCE OF 48.59 FEET TO A CONCRETE MONUMENT, THENCE RUN NORTH 01*220*" WEST, A DISTANCE OF 48.59 FEET TO A CONCRETE MONUMENT, THENCE RUN NORTH 01*220** WEST, A DISTANCE OF 48.59 FEET TO A RUN THE MONUME THENCE RUN NORTH 07:2207 WEST, A DISTANCE OF 80:39 FEET TO AN IRON PIPE ON THE EXISTING SOUTHERLY RIGHT-OF-WAY LINE OF NUMBER 20:32EAST, ALONG SAID SOUTHERLY RIGHT-OF-WAY LINE, A DISTANCE OF 98:22 FEET TO A SET NAIL AND DISTANCE OF 18:22 FEET TO A SET NAIL AND DISTANCE OF 18:22 FEET TO A SET NAIL AND DISTANCE OF 18:22 FEET TO AN IRON PIPE ON THE EXISTING NORTHERLY RIGHT-OF-WAY, LINE OF N.W. 1ST AVENUE (A 40 FOOT RIGHT-OF-WAY), THENCE RUN SOUTH 89:13:22: WEST, ALONG SAID NORTHERLY AVENUE (A 40 FOOT RIGHT-OF-WAY), THENCE RUN SOUTH 89:13:22: WEST, ALONG SAID NORTHERLY RIGHT-OF-WAY LINE, A DISTANCE OF 250,24 FEET TO THE POINT OF BEGINNING.

TAX PARCEL #14260-001-000

TAX PARCEL #14280-001-000 (OFFICIAL RECORDS BOOK 2022, PAGE 540)
THE EAST 150 FEET OF BLOCK 19 OF BRUSH'S ADDITION TO GAINESVILLE AS PER MAP OR PLAT THEREOF AS RECORDED IN DEED BOOK "O", PAGE 218 OF THE PUBLIC RECORDS OF ALACHUA COUNTY, FLORIDA, LESS AND EXCEPT THE FOLLOWING DESCRIBED PARCEL: COMMENCE AT THE NE CORNER OF BLOCK 19, BRUSH ADDITION, DEED BOOK "O", PAGE 219 RUN SOUTH 89 DEGREES, 10 MINUTES AND 57 SECONDS WEST 96.00 FEET TO THE POINT OF BEGINNING; THENCE RUN SOUTH 61 DEGREES, 22 MINUTES AND 25 SECONDS EAST 18.29 FEET; THENCE RUN NORTH 89 DEGREES, 28 SECONDS AND 32 MINUTES WEST 10.05 FEET; THENCE RUN NORTH 61 DEGREES, 22 MINUTES AND 25 SECONDS EAST 10.05 FEET; THENCE RUN NORTH 67 DEGREES, 22 MINUTES AND 25 SECONDS EAST 10.00 FEET TO THE POINT OF BEGINNING. ALL LYING AND BEING IN THE NORTHEAST 1/4 OF SECTION 5, TOWNSHIP 10 SOUTH, RANGE 20 EAST.

FIRE AND LIFE SAFETY SERVICES:

- THE DEVELOPMENT SHALL COMPLY WITH THE FLORIDA FIRE PREVENTION CODE. [GAINESVILLE FIRE PREVENTION AND PROTECTION CODE SECTION 10-5 (A) AND (B)] FIRE HYDRANTS AND STABILIZED SURFACES SHALL BE IN SERVICE PRIOR TO THE ACCUMULATION OF COMBUSTIBLES ON SITE. [GAINESVILLE FIRE PREVENTION AND PROTECTION CODE SECTION 10-9 (NFPA
- COMBUSTIBLES ON SITE. [GAINESVILLE FIRE PREVENTION AND PROTECTION COUR SECTION 10-9 (NPFA 1-16.4.3)]
 IN-BUILDING PUBLIC SAFETY RADIO ENHANCEMENT SYSTEMS SHALL BE PROVIDED IN ALL BUILDINGS WHERE MINIMUM RADIO SIGNAL STRENGTH FOR FIRE DEPARTMENT COMMUNICATIONS IS NOT ACHIEVED AT A LEVEL DETERMINED BY THE AHA. IT IS HIGHLY RECOMMENDED THAT DEVELOPERS EVALUATE AND ADDRESS THE POTENTIAL NEED FOR IBPRES IN THE EARLY STAGES OF PROJECT PLANNING, FOR ADDITIONAL SPECIFIC REGUIREMENTS PERTAINING TO SIGNAL STRENGTH, COVERAGE, MANITENANCE AND TESTING REFER TO NEPA 72-14,4.12 AND 24.5.2. [GAINESVILLE FIRE PREVENTION AND PROTECTION CODE SECTION 10-9 (MPFA 1-11.10)]
- AND PROTECTION CODE SECTION 10-9 (NFPA 1-11.10)]
 THE OWNER OR THE OWNER'S AUTHORIZED AGENT SHALL DEVELOP A FIRE SAFETY PROGRAM TO
 ADDRESS ALL ESSENTIAL FIRE AND LIFE SAFETY REQUIREMENTS FOR THE DURATION OF DEMOLITION,
 ALTERATION AND CONSTRUCTION. AS SPECIFIED IN THE FLORIDA FIRE PREVENTION CODE, INCLUDING NFPA 241, THE FIRE SAFETY PROGRAM SHALL INCLUDE AN EMERGENCY RESPONSE PLAN, AS WELL AS IDENTIFYING FIRE PREVENTION PRECAUTIONS, SITE AND BUILDING EMERGENCY ACCESS ROUTES. TEMPORARY AND PERMANENT WATER SUPPLIES, BUILDING EGRESS ROUTES, GOOD HOUSEKEEPING PRACTICES, AND FIRE PROTECTION SYSTEM INSTALLATION AND MAINTENANCE. IGAINESVILLE FIRE PREVENTION AND PROTECTION CODE SECTION 10-9 (NFPA 1-16))

DEVELOPMENT INFORMATION:

2. ADDRESS:

3. PROJECT DESCRIPTION: THE PROJECT CONSISTS OF THE CONSTRUCTION OF A MIXED USE APARTMENT COMPLEX WITH 129 RESIDENTIAL

UNITS, RETAIL FACADE ALONG UNIVERSITY AVE., PARKING, AND ASSOCIATED STREETSCAPE.

STORMWATER, AND UTILITY IMPROVEMENTS.

10' ON ARTERIAL STREETS AND 7' LOCAL STREETS

14' FOR ARTERIAL ROADS AND 11' FOR LOCAL STREETS PER TRADITIONAL

CCD - CENTRAL CITY DISTRICT

MIXED USE RESIDENTIAL

CITY SPECIAL DEV. PLAN

12 STORIES

NONE REQUIRED

110.538 S.F. / 2.54 A.C. 4. TOTAL PROJECT AREA:

ZONING STANDARDS:

1. TOTAL IMPERVIOUS AREA:

SMF ID DESCRIPTION LOWEST DISCHARGE 173.50 FT-NAVD 173,50 FT-NAVD RETENTION VOLUME 0.250 AC-FI

0.075 AC

RETENTION AREA AT

7. THIS SITE IS LOCATED IN THE "TRADITIONAL CITY OVERLAY DISTRICT"

8. THIS SITE IS NOT LOCATED IN A HISTORIC DISTRICT

Always call 811 two full business days before you dig to Sunshine 811.com

STORMWATER INFORMATION:

OWNER: KLM Properties Inc. 101 SE 2nd Place Suite 202 2. TOTAL SEMI-IMPERVIOUS AREA: 0.000 AC Gainesville, FL 32601 Contact: Ken McGurn Phone: (352) 372-6172

0.069 AC

14 E. University Avenue Suite 206 Gainesville, FL 32601 Contact: Daniel Davila P.E.

LANDSCAPE ARCHITECTURE: Chen Moore & Associates
14 E. University Avenue Suite 206
Gainesville, FL 32601
Contact: Cristobal Betancourt R. L. A.

ARCHITECTURAL: 791 Park of Commerce Blvd #400 Boca Raton, FL 33487 Conlact: Bruno Phillips bphillips@pgal.com (561) 988-4002

> Sainesville, FL 32608 Contact: Corey A. Dunlap P.E. (352) 377-3233

Sheet List Table **Drawing No** Sheet Title **COVER SHEET** C0.01 **SPECIFICATIONS BOUNDARY AND TOPOGRAPHIC SURVEY** C1.01 EXISTING CONDITIONS AND DEMOLITION PLAN C2.01 SITE PLAN - GROUND LEVEL C3.01 **PAVING AND DRAINAGE PLAN** C3.02 **PAVING AND DRAINAGE DETAILS** C3.03 **PAVING AND DRAINAGE DETAILS** C4.00 C4.01 WATER AND SEWER PLAN C4.02 **WATER AND SEWER DETAIL SHEET** C5.01 SIGNAGE AND MARKING PLAN C6.01 STORMWATER POLLUTION PREVENTION PLAN C6.02 STORMWATER POLLUTION PREVENTION DETAILS L1.01 TREE DISPOSITION PLAN 11.02 TREE DISPOSITION CHART LANDSCAPE PLAN - GROUND LEVEL L2.01 LANDSCAPE DETAILS L2.02 L3.01 LIGHTING PLAN - GROUND LEVEL L3.02 LIGHTING DETAILS A1.00 **ARCHITECTURAL SITE PLAN** A2.02 SECOND FLOOR PLAN A2.03 THIRD FLOOR PLANS A2.04 **ROOF PLAN** A4.00 **UNIT FLOOR PLANS** A4.01 **ENLARGED GROUND FLOOR PLANS OVERALL EXTERIOR ELEVATIONS** A6.00 A6.10 BUILDING SECTION

SECTION 05, TOWNSHIP 105, RANGE 205 LOCATION MAP

PROJECT CONTACT INFO:

NW 2ND AVE

GSE Engineering & Consulting, Inc. 5590 SW 64th Street, Suite B



PROJECT

LOCATION

&ASSOCIATES

14 East University Avenue Suite 206 Gainesville, FL 32601 352.374.1997

www.chenmoore.com

CERTIFICATES OF AUTHORIZATION

EB4593 LC26000425

PROJECT NUMBER 15-195.004 CLIENT PROJECT NUMBER

DRAWING NUMBER COV

1. ZONING:


2. FUTURE LAND USE:

4. SIDEWALK WIDTH:

5 SETRACKS

6. BUILD-TO LINE:

3. MAX. BUILDING HEIGHT:

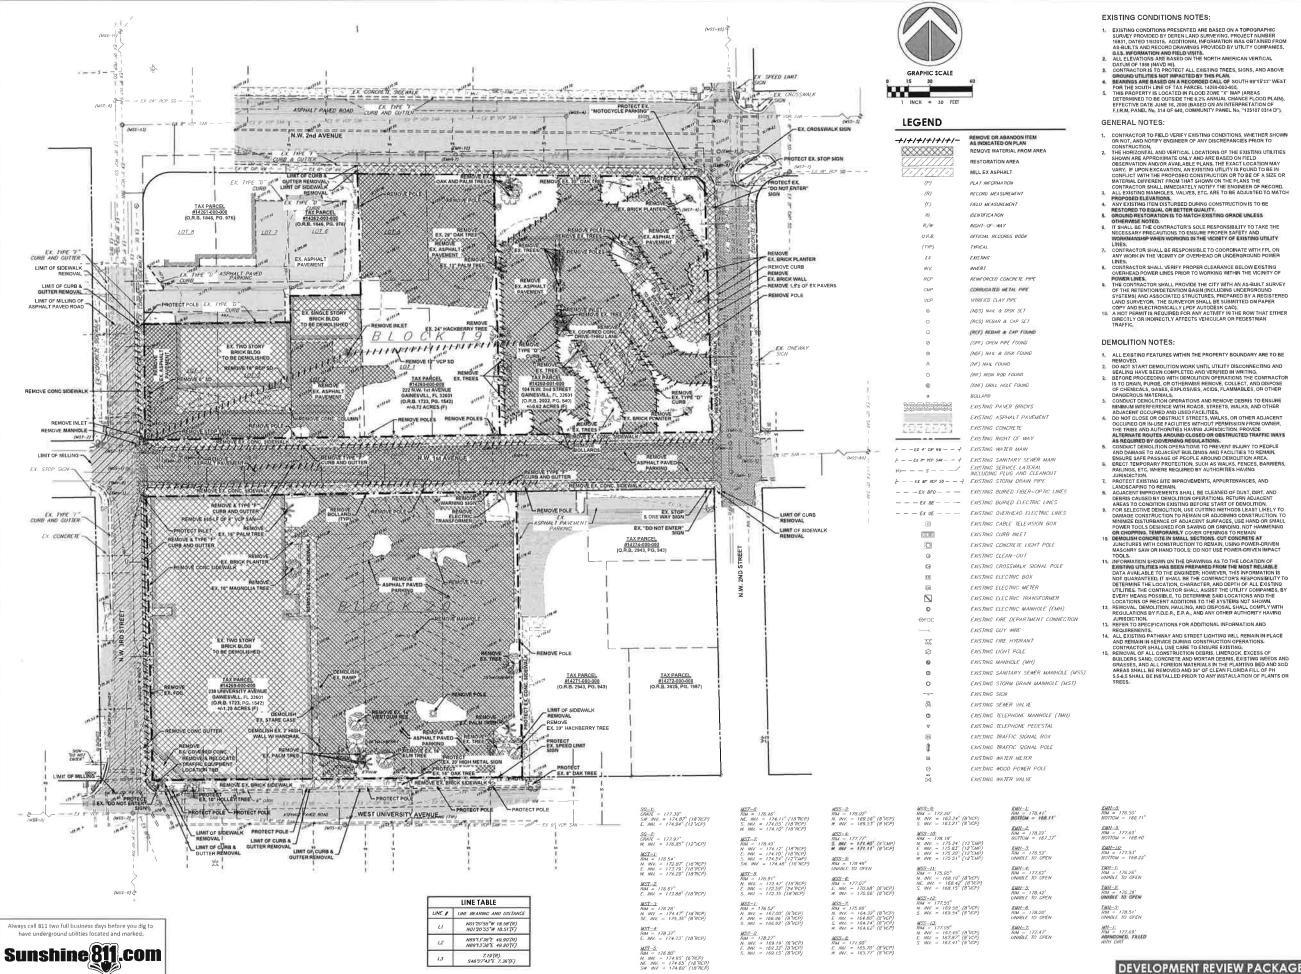

CHEN-MODRE

&ASSOCIATES 14 East University Avenue Suite 206 Gainesville, FL 32601 352,374,1997

CERTIFICATES OF AUTHORIZATION EB4593 LC26000425

REGISTRATION NO. ----

REGISTRATION

SUB-CONSULTANT

KLM Properties Inc.

PROJECT INFORMATION

238 W UNIVERSITY

GAINESVILLE, FLORIDA PROJECT NUMBER

15-195.004

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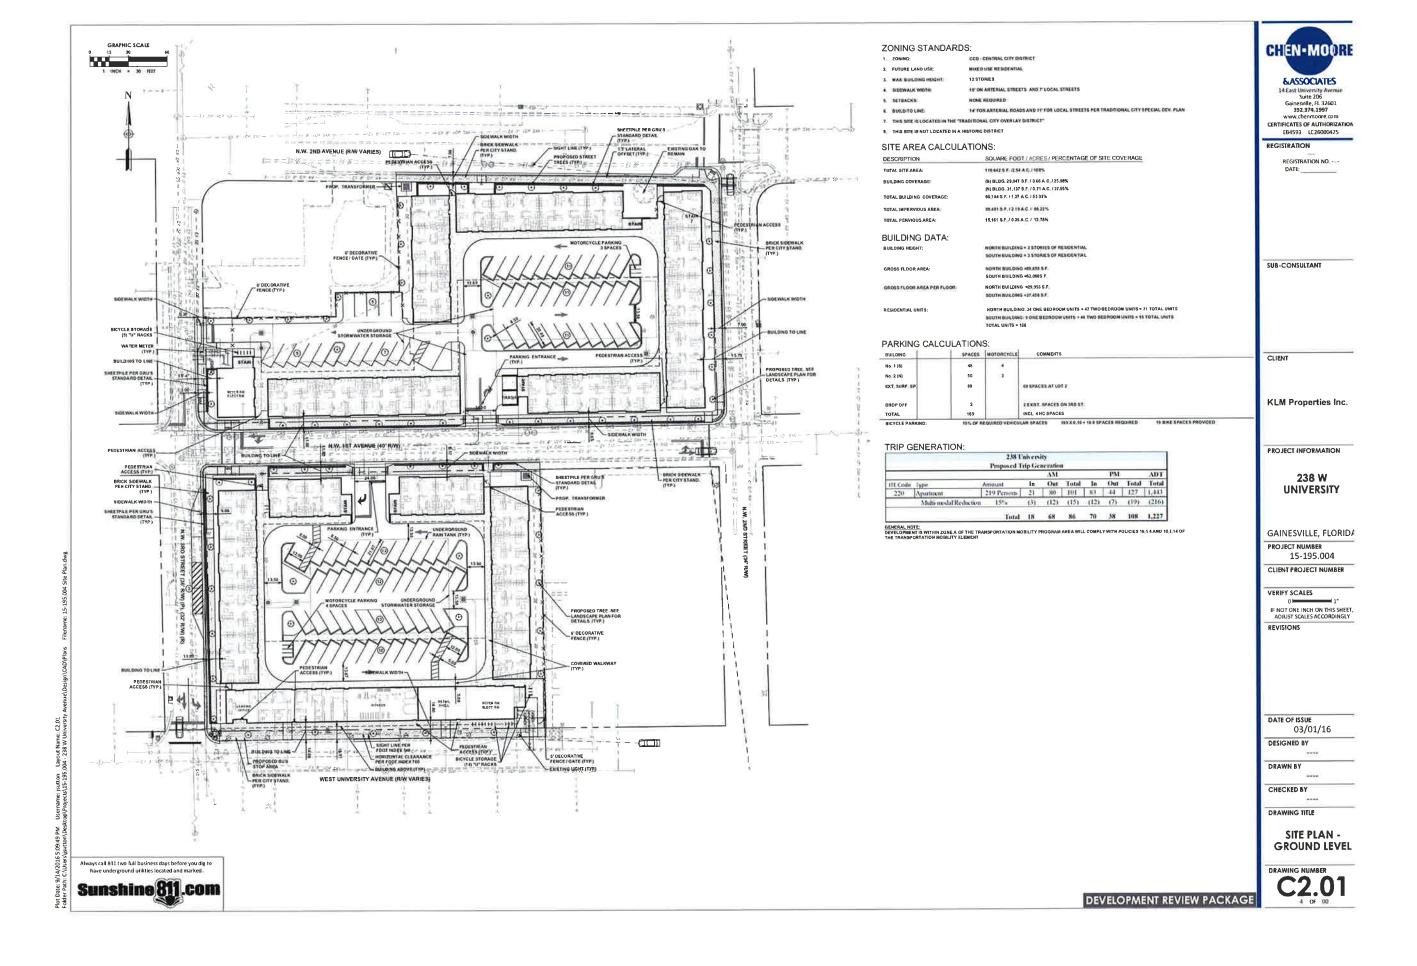
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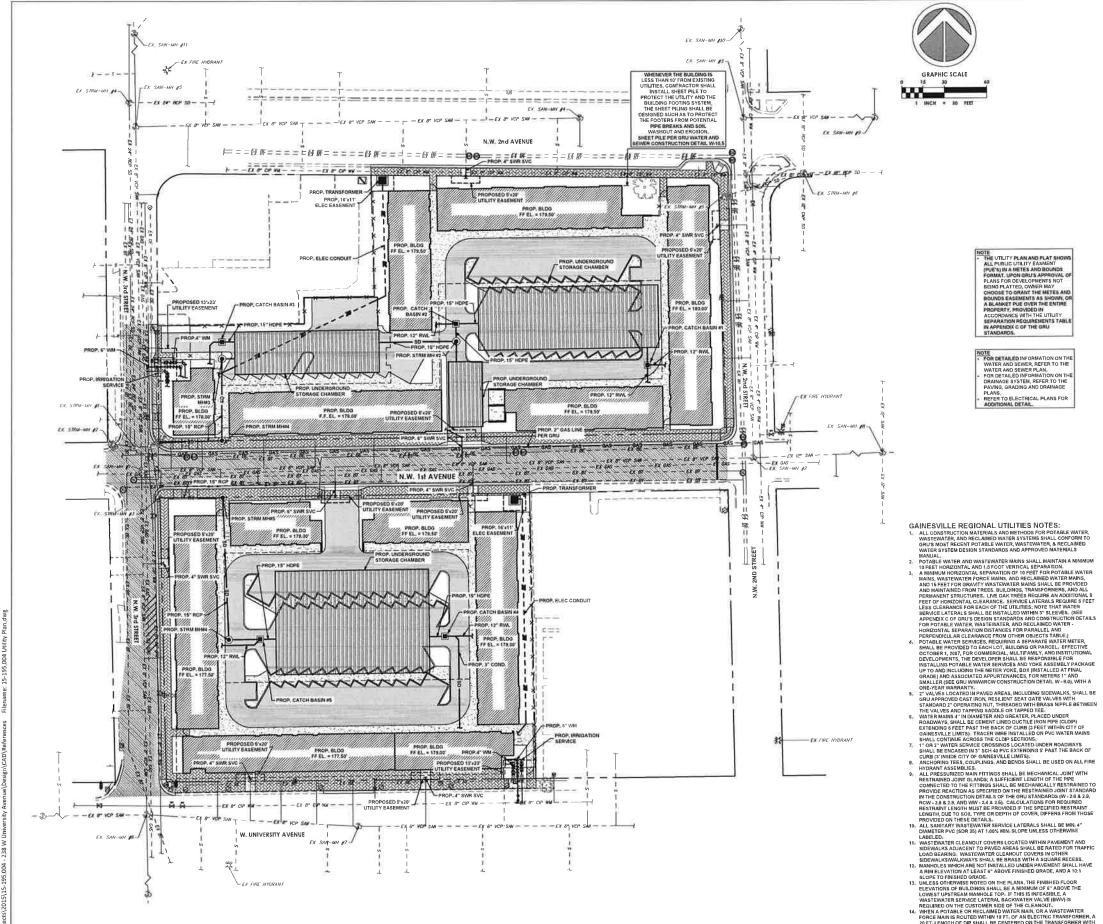
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DRAWING TITLE

EXISTING CONDITIONS AND DEMOLITION PLAN

DRAWING NUMBER C1.0







2 - - EX + CMP WH - - 2 EXISTING WATER MAIN

H----(1111111)

NOTE

THE UTILITY PLAN AND PLAT SHOW
ALL PUBLIC UTILITY EASMENT
(PUE'S) IN A METES AND BOUNDS
FORMAT, UPON GRUS APPROVAL
PLANS FOR DEVELOPMENTS NOT N APPENDIX C OF THE GRU

HOTE
FOR CETALED INFORMATION ON THE
WATER AND SEWER, REFER TO THE
WATER AND SEWER PLAN.
FOR DETAILED INFORMATION ON THE
DRAININGS SYSTEM, REFER TO THE
PAVING, GRADING AND DRAINAGE

GAINESVILLE REGIONAL UTILITIES NOTES:

1. ALL CONSTRUCTION MATERIALS AND METHODS FOR POTABLE WATER WASTEWATER, AND RECLAMBED WATER SYSTEMS SHALL CONFORM THE GROUP BY THE CONFORM THE CONF

WAITER SYSTEM DESIGN STANDARDS AND APPROVED MATERIALS
MANUAL.

2. POTABLE WATER AND WASTEWATER MAINS SHALL MAINTAIN A MINIMUM
10 FEET HORIZONTAL AND LIS FOOT VERTICAL SEPARATION
3. MAINS, WASTEWATER FORCE MAINS, AND RECLAMBED WATER MAINS,
AND IS FEET FOR GRAVITY WASTEWATER MAINS SHALL BE PROVIDED
AND MAINTAINED FROM TREES, BUILDINGS, TRANSFORMERS, AND ALL
PERMANENT STRUCTURES, LIVE DAN TREES REQUIRE AN ADOITIONAL 5
FEET OF HORIZONTAL CLEARANCE, SERVICE LATERIALS REQUIRE SYFEET
LESS CLEARANCE FOR HEAD OF THE UTILITIES, WOULD SHEET
APPENDIX C OF GRU'S DESIGN STANDARDS AND CONSTRUCTION DETAILS
FOR POTABLE WATER MASTEWATER, AND RECLAMBED WATER
HORIZONTAL SEPARATION DISTANCES FOR PARALLEL AND
PERMENDICULAR CLEARANCE FROM THE GUILEFANLY FAILE
4. POTABLE WATER MASTEWATER, AND RECLAMBED WATER
CONTIDEER, THE DEVELOPER'S HALL BE RESPONSIBLE FOR
INSTALLING POTABLE WATER WATER SERVICES, REQUIRING A SEPARATE WATER METER
COTTOBER, 2017, FOR COMBERGIAL MULTIFAMILY AND INSTITUTIONAL
DEVELOPMENTS, THE DEVELOPER'S HALL BE RESPONSIBLE FOR
INSTALLING POTABLE WATER WATER SERVICES, BOY ONE STALLED AT FINAL
GRADEJ AND ASSOCIATED APPURTEMANCES, FOR METERS
UP TO AND INCLUDING THE METER YOKE, BOX (INSTALLED AT FINAL
GRADEJ AND ASSOCIATED APPURTEMANCES, FOR METERS IT AND
SMALLER (SEE GRU WWW.WRCW/CONSTRUCTION SIDEMANCES, STANLE BE
5. "YALLY ELOCATED IN PAYED AREAS. INCLUDING SIDEMANCES, SHALL BS
5. "YALLY ELOCATED IN PAYED AREAS. INCLUDING SIDEMANCES, SHALL BS
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5."

WIDENMY ASSEMBLIES.

ALL PRESSURZED MAIN PITTINGS SHALL BE MECHANICAL JOINT WITH RESTRAINED JOINT GLANDS: A SUFFICIENT LENGTH OF THE PIPE CONNECTED TO THE FITTINGS SHALL BE MECHANICALLY RESTRAINED JOINT STANDARD IN THE CONSTRUCTION DETAILS OF THE GRUST AND AND WITHER CONSTRUCTION DETAILS OF THE GRUST STANDARD WITHER CONSTRUCTION DETAILS OF THE GRUST STANDARD RESTRAINT LENGTH MUST LISE PROVIDED IT THE SPECIFIED RESTRAINT END THAT THE PROPRIED RESTRAINT END THAT THE PROPRIED RESTRAINT FOR THE PROPRIED OF THE SPECIFIED RESTRAINT FOR THE STANDARD RESTRAINT FO

DIAMETER PVC (SDR 15) A1 1,00% mins, above unless that Labeled, was tewarter cleanout covers located within pavement and sidewalks adjacent to paved areas shall be rated for traffic load bearing, was tewarter cleanout covers in other sidewalksmak(ways shall be brack) and the sidewalksmak(ways shall be brack). Be the shall be received the sidewalksmak(ways shall be brack) and shelf shall have a fall be with a source which are not installed under pavement shall have a fine elevation at least 5° above finished orade, and so it is slope to finished orade. And so it is slope to finished orade. And so it is shall be such as the side of the shall be shall be

IN IN LEVATION AT LEAST 5" ABOVE FINISHED GRADE, AMD A 10.1 SLOPE TO FINISHED GRADE.

13. UNLESS OTHERWISE MOTEO ON THE PLANS, THE FINISHED FLOOR ELEVATIONS OF BUILDINGS SHALL BE A MINISHED FLOOR ELEVATIONS OF BUILDINGS SHALL BE A MINISHM OF 6" ABOVE THE LOWEST UPSTREAM MANHOLE TOP, IF THIS IS INFEASIBLE, A WASTEWATER SERVICE LIFERAL BACKWATER VALVE (BWY) IS REQUIRED ON THE CUSTOMER SIDE OF THE CLEAROUT.

WHEN A POTABLE OR RECLIMABED WATER MINISHM CONTAGE TRANSFORMER, AT A CONTAGE TRANSFORMER, A TOP THE WASTEWATER OF THE THE ANSPORMER OF THE THE ANALYSIS AND A COLOR WITHIN 10 FT. OF THE MEAREST EDGE OF THE TRANSFORMER, A MINISHM CLEARANCE OF 3'S SHALL BE MAINTAINED BETWEEN THE MAIN AND THE TRANSFORMER. A

LEGEND

PROPOSED ASPHALT MILL & RESURFACING

PROPOSED WATER MAIN

PROPOSED TAP SLEEVE AND VALVE PROPOSED BACKFLOW PREVENTER CAS - GAS - PROPOSED NATURAL GAS LINE

2 - - EX 8" VOP SM - - 2 EXISTING SANITARY SEWER MAIN EXISTING SERVICE LATERAL INCLUDING PLUG AND CLEANOUT } - - EX 18" NOP SD - - ? EXISTING STORM DRAIN PIPE → - EX BE - - → EXISTING BURIED ELECTRIC LINES → — EX GE — — → FXISTING OVERHEAD ELECTRIC LINES. EXISTING CABLE TELEVISION BOX EXISTING CURB INLET

> EXISTING CONCRETE LIGHT POLE EXISTING CLEAN-OUT EXISTING CROSSWALK SIGNAL POLE EXISTING ELECTRIC BOX EXISTING FLECTRIC METER EXISTING ELECTRIC TRANSFORMER EXISTING ELECTRIC MANHOLE EXISTING FIRE DEPARTMENT CONNECTION EXISTING GUY WIRE EXISTING FIRE HYDRANT

> > EXISTING LIGHT POLE

EXISTING MANHOLE EXISTING SANITARY SEWER MANHOLE EXISTING STORM WATER MANHOLE EXISTING SEWER VALVE EXISTING TRAFFIC SIGNAL POLE

EXISTING WOOD POWER POLE EXISTING WATER VALVE EXISTING RIGHT-OF-WAY

EXISTING REINFORCED CONCRETE PIPE EXISTING CORRUGATED METAL PIPE EXISTING WIRIFIED CLAY PIPE

> GAINESVILLE, FLORIDA PROJECT NUMBER

15-195.004

VERIFY SCALES

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REVISIONS

GENERAL NOTES:

ENDEMAL IND LESS:

CONTRACTOR TO PIELD VERIFY EXISTING CONDITIONS, WHETHER SHOWN OR NOT, AND NOTIFY ENGINEER OF ANY DISCREPANCIES PRIOR TO CONSTRUCTION.

THE HORIZONTAL AND VERTICAL LOCATIONS OF THE EXISTING UTILITIES SHOWN ARE AFFOXIMATE ONLY AND ARE BASED ON FIELD

OBSERVATION AND/OR AVAILABLE FLANS. THE EXACL FOUND MAY OBSERVATION AND/OR AVAILABLE FLANS THE EXACL FOUND MAY OBT OR OR OF THE OWNER OWNER OWNER OF THE OWNER OWNER

MATERIAL DIFFERENT FROM THAT SHOWN ON THE PLANS THE CONTRACTOR SHALL IMBEDIATE NO NOTHE THE ENGINEER OF RECORD.

3. ALL EXISTING MANHOLES, VALVES, ETG, ARE TO BE ADJUSTED TO MATCH PROPOSED E LEVATIONS.

4. ANY EXISTING ITEM DISTURBED DURING CONSTRUCTION IS TO BE RESTORED TO SQUAL OR BETTER QUALITY.

5. PAVEMENT AND DRIVEWAY RESTORATION ARE TO MATCH EXISTING GRADE UNLESS OTHERWISE NOTED.

5. IT SHALL BE THE CONTRACTOR'S SOLE RESPONSIBILITY TO TAKE THE NECESSARY PRECAUTIONS TO ENSURE PROPER SAFETY AND WORKMANSHIP WHEN WORKING IN THE VICINITY OF EXISTING UTILITY LINES.

WORKMANSHIP WHEN POOLSTONED TO COORDINATE WITH FPL ON ANY WORK IN THE VICINITY OF OVERHEAD OR UNDERGROUND POWER

Always call 811 two full business days before you dig to



DEVELOPMENT REVIEW PACKAGE

CHEN-MOORE

&ASSOCIATES 14 East University Avenue Suite 206 352.374.1997 CERTIFICATES OF AUTHORIZATION

REGISTRATION

REGISTRATION NO. --DATE:

SUB-CONSULTANT

CLIENT

KLM Properties Inc.

PROJECT INFORMATION

238 W UNIVERSITY

CLIENT PROJECT NUMBER

DATE OF ISSUE

03/01/16

DESIGNED BY


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MASTER UTILITY PLAN

DRAWING NUMBER C4.00



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TREE DISPOSITION PLAN


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TREE DISPOSITION NOTES

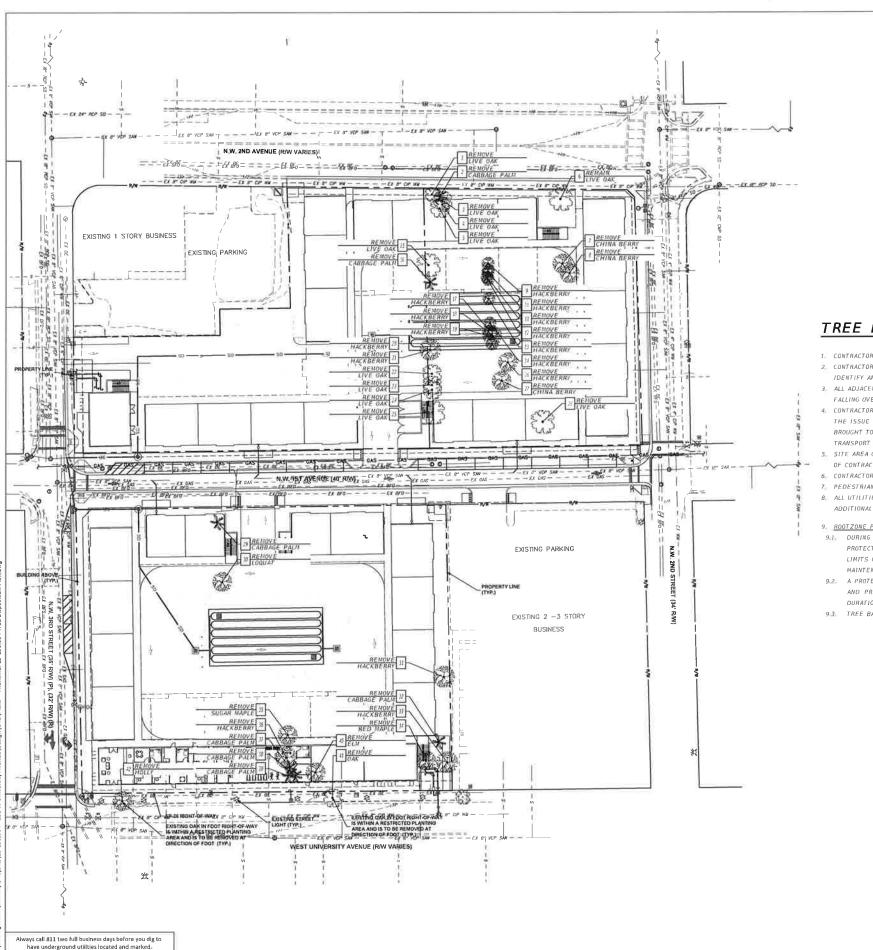- CONTRACTOR SHALL SECURE ALL APPLICABLE TREE REMOVAL PERMITS FOR THE SITE PRIOR TO MOBILIZATION.
- 2. CONTRACTOR SHALL VERIFY ALL UNDERGROUND UTILITY LOCATIONS PRIOR TO BEGINNING WORK IT IS THE CONTRACTOR'S RESPONSIBILITY TO IDENTIFY ANY ABOVE OR BELOW GROUND STRUCTURES OR SERVICES THAT IMPACT THIS PROJECT.
- 3. ALL ADJACENT PROPERTIES AND AREAS ACCESSIBLE TO THE PUBLIC AND EXTERIOR PROPERTY LINES SHALL BE PROTECTED AGAINST DEBRIS FALLING OVER THE PROPERTY LINES
- 4 CONTRACTOR SHALL INSPECT & ASSESS THE SITE TO FULFILL THE INTENT OF THE WORK REQUIRED BY THE CONTRACT DOCUMENTS AND PRIOR TO THE ISSUE OF THE GUARANTEED MAXIMUM PRICE. DEVIATIONS FROM THE CONTRACT DOCUMENTS REQUIRED BY FIELD CONDITIONS SHALL BE BROUGHT TO THE ATTENTION OF THE ARCHITECT FOR REVIEW BEFORE PROCEEDING, DEMOLISHED & REMOVED ITEMS SHALL BE DISCARDED. TRANSPORT DEMOLISHED MATERIALS OFF OWNER'S PROPERTY AND LEGALLY DISPOSE OF THEM.
- 5, SITE AREA CLEAN UP MUST TAKE PLACE SEVERAL TIMES A DAY OR WHEN NEEDED. REMOVAL FROM CONSTRUCTION SITE IS THE RESPONSIBILITY
- 6 CONTRACTOR SHALL MAINTAIN CLEAN, CLEAR, AND SAFE PUBLIC ACCESS AT ALL TIMES.
- 7, PEDESTRIAN ACCESS SHALL BE MAINTAINED TO ALL ADJACENT FACILITIES DURING CONSTRUCTION
- 8. ALL UTILITIES, STRUCTURES AND OTHER INFORMATION IDENTIFIED ON THIS PLAN ARE BASED ON THE SURVEY. REFER TO SURVEY FOR ADDITIONAL INFORMATION ON EXISTING CONDITIONS


9 ROOTZONE PROTECTION


- 9.1. DURING THE ENTIRE CONSTRUCTION PERIOD ALL REASONABLE EFFORTS SHALL BE MADE TO PROTECT THE ROOT ZONE FROM DAMAGE TREE PROTECTION BARRICADING SHALL BE ERECTED AROUND THE TREES, ALL PLANT MATERIAL DESIGNATED TO BE SAVED, OR OUTSIDE OF TH LIMITS OF CONSTRUCTION, SHALL BE PROTECTED DURING CONSTRUCTION WORK, WORK UNDER THESE ITEMS WILL INCLUDE CONSTRUCTION A MAINTENANCE OF TEMPORARY BARRICADE FENCING TO PROTECT THE ROOT ZONES OF EXISTING TREES AND OTHER PLANTINGS.
- 9.2. A PROTECTION BARRIER OR TEMPORARY FENCE OF AT LEAST 4 FEET IN HEIGHT SHALL BE INSTALLED AROUND EACH TREE TO BE PROTECTED. AND PRESERVED. THE TREE PROTECTION SHALL BE INSTALLED PRIOR TO THE ACTUAL CONSTRUCTION START AND MAINTAINED FOR THE
- 9.3 TREE BARRICADE FENCING SHALL BE; AS PER THE APPLICABLE DETAIL(S).

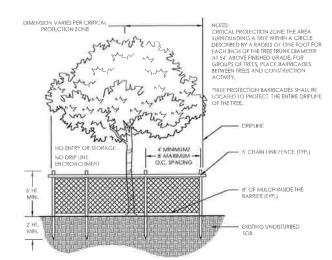

TREE PRESERVATION BARRICADE FENCING

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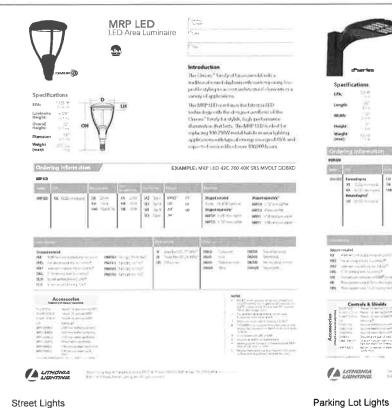
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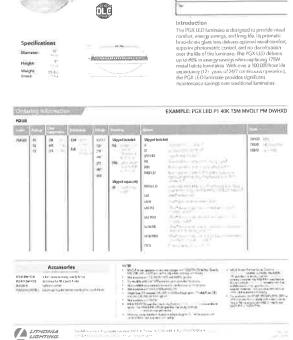
LIGHTING PLAN -

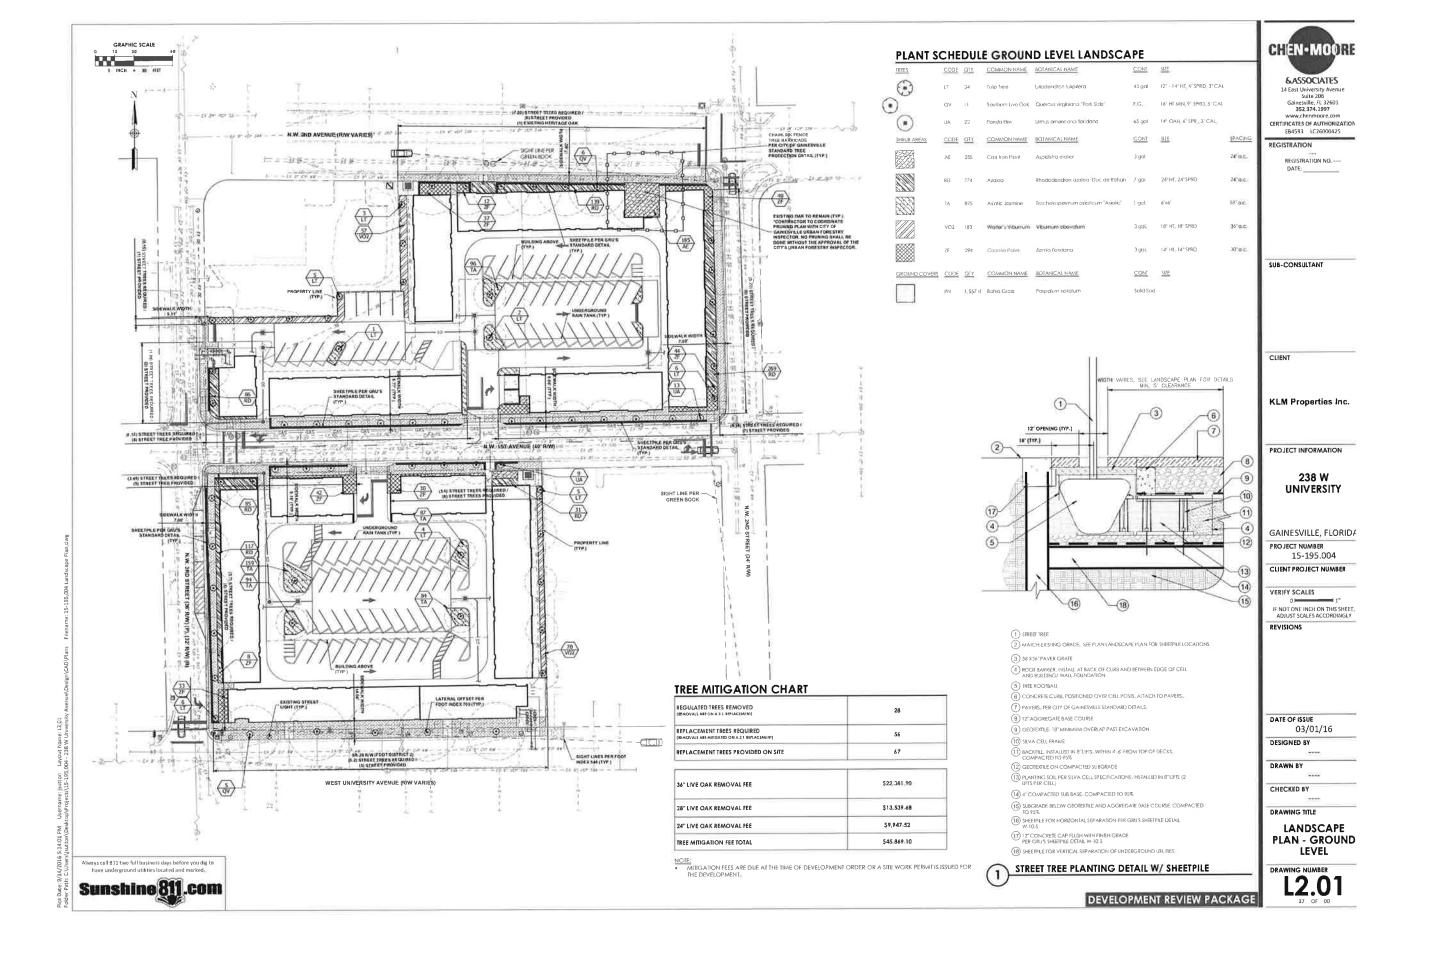L3.01
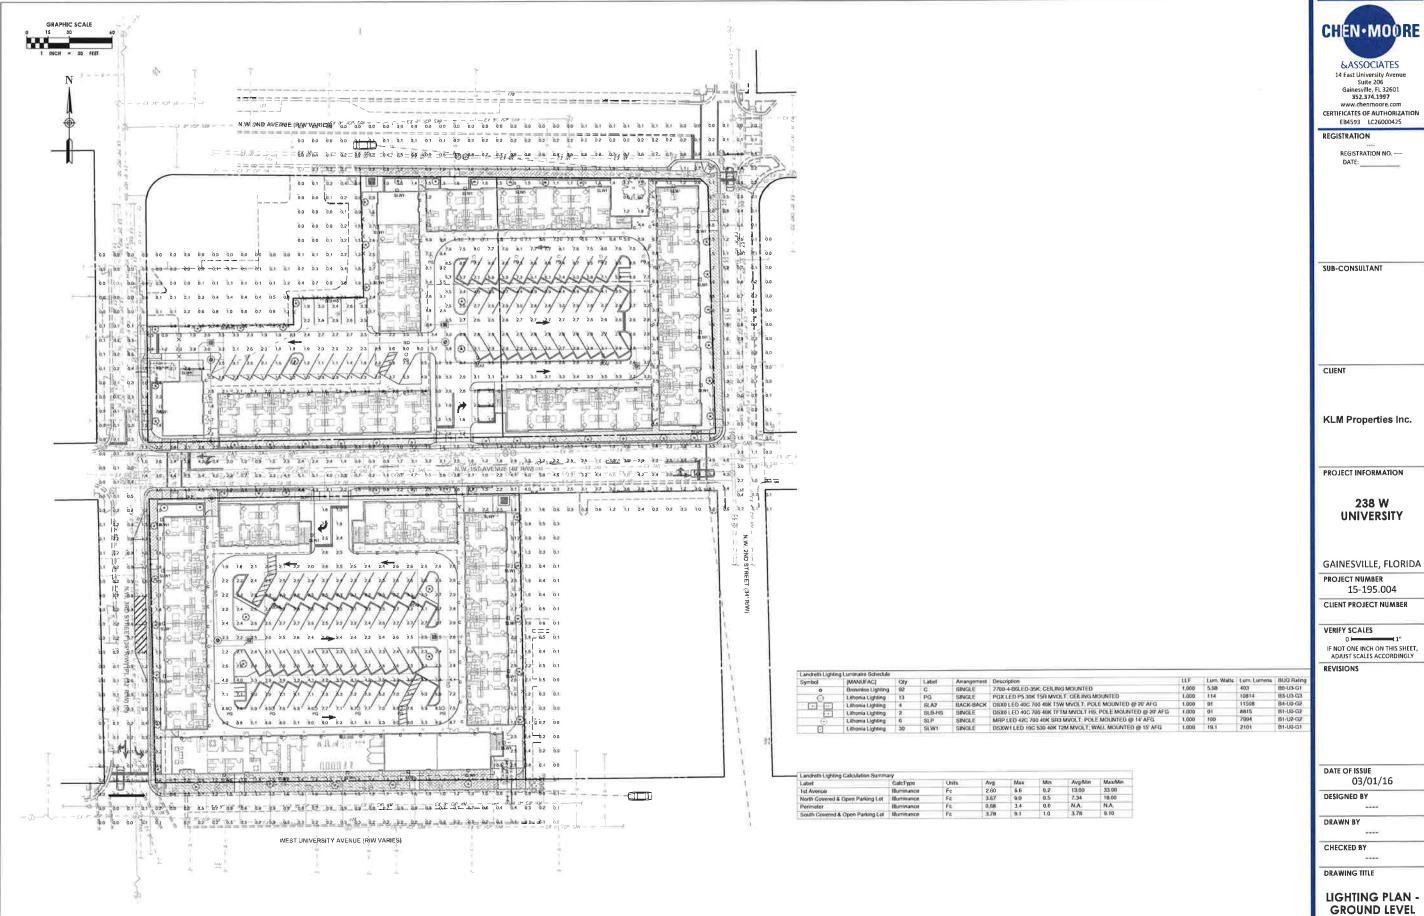
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Parking Garage Light

PGX LED

Wall Light

CORT CANADA CANA Consideration of the second process of the second s

D-Series Size 1

Introduction
The Section Stylish, fully mit passed III will be stylish for the ding mount of a market stylish for the stylish for the stylish for the stylish stylish

EXAMPLE: DSXW1 LED 20C 1000 40K T3M MVOLT DDBTXD

1 1

Back Box (BBW, ELCW) Width: 'J-3/4' 88W Weights
Depth Weights

Height: 1-3/1/

7700 LED to necessary - Kent (Moses)

Lich A. Bill and J. Bry (Block) - Language and Languag B1325" 325" 625" WET LA TIE 7700 BL Sunk BZ Sink /A II Tsubs or WHI /IIIIR 4 THE Morraine Manager BROWNLEE FIRST

CEILING MOUNTED

Specifications and dimensions subject to change without notice

Always call 811 two full business days before you dig to have underground utilities located and marked.

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DEVELOPMENT REVIEW PACKAGE

KLM Properties Inc. PROJECT INFORMATION 238 W UNIVERSITY GAINESVILLE, FLORIDA PROJECT NUMBER 15-195.004 CLIENT PROJECT NUMBER VERIFY SCALES

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&ASSOCIATES

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LIGHTING **DETAILS**

DRAWING NUMBER L3.02

N.W. 2ND AVENUE (R/W VARIES) 0 8 FT HT. DECORATIVE FENCE [1] 五章五 五章五 五章五 五章 FIRE PUMP ELECT RM 7 PARALLEL PARKING SPACES 5 p' LOADING N.W. 1ST AVENUE (40' BAV) 11FT BULD TO UNE RACKS EXST. TRANS. TO PROP.
AS REPLACED TRANS. STOP RACKS STAR B 1 TO P B C STAR TULL TU ※言を 000033

ARCHITECTURAL SITE PLAN

151151

PROJECT DATA BUILDING GENERAL APPLICABLE CODES: FIB. 2014 STH EDITION, FFPG STH EDITION (NFPA 1 AND 101)

- OCCUPANCY TYPE - R.Z. MULTI FAMILY COMMERCIAL DEVELOPMENT.

- CONSTRUCTION TYPE: III. - PER ITABLE 503 AND 603, MON COMBUSTIBLE NON BEARING WOOD PARTITIONS, EXT WALLS AND ROOP CONSTRUCTION.

- BULLDINGS STOMES

- BULLDINGS STOMES

- BULLDINGS STOMES

- BULLDINGS STOMES

- BULLDING STOMES

- PER RET ABLE 503, 14 (3) 1 HOUR SEPARATION REQUIRED.

- PER RET TABLE 503 478 FIRE RESISTANCE RATING.

- (3) OPEN MEANS OF EGRESS STAIRS PROVIDED FOR EACH BUILDING, TRAVEL DISTANCE 200 FT. 82,068 APPROX_27_456 / FLR BLDG, No.1 3) BLDG No 2 89,859 APPROX, 29,953 / FLR EASING AINT_OFFICE 1,850 DOUBLE HT. LOBBY CEILING TNESS SHELL SPACE AT UNIVERSITY AVE, TAIL SHELL 1.584 SETBACKS REQUIRED: TOTAL UNIT COUNT - BUILDING No. 1 AND 2 (3 RES. FLOORS (CCD) - NONE REQUIRED TRADITIONAL CITY SPECIAL DEV, PLAN - BUILD TO LINES: ARTERIAL RD (14 FT) AND LOGAL RD (11 FT) 1 BEDROOM 29.46% BUILT TO LIVE PROVIDED. MOORGOM 91 70,54% SOUTH BUILDING:
W. UNIVERSITY AVE: "
W. UNIVERSITY AVE: "
WITH AVE BUILDING SPACES MOTORCYCLE NORTH BUILDING: NW 1ST AVE: 18'-8" NW 2ND AVE: 11'-6" NW 2ND STREET: 14'-9" NW 3RD STREET: 15'-0" Na. 1 (S) 51 No. 2 (N) EXT, SURF, S 14 PARRALEL SPACES ON 1ST AVE 55 EPACES AT LOT 2 1ST AVE ONE WAY. + (T) LOACHIG 2 EXIST, SPACES ON 3RD ST. FULL BALCONIES (ALL WITHIN RAW) 184 $8^{+}6^{+}$ X 18 FT DP ANGLED, $8^{+}6^{+}$ X 20*-0* 90 DEGREE AND 8^{+} X 20* PARALLEL PARKING STALLS PER CITY ENG., STANDARDS APPENDIX B-2 THIS SITE IS NOT LOCATED WITHIN THE HISTORIC DISTRICT OR FLOOD PLAIN. KNOX BOX WILL BE PROVIDED TO ENSURE EMERGENCY ACCESS TO THE "RESTRICTED ACCESS OCCUPANCY", PER GAINESVILLE FIRE PREVENTION AND PROTECTION CODE SECTION 10-18(b).

25 410H 220H 220H 220H 240H 25 HOH 240H 25 HOH 25 H



KEY PLAN

1"= 50"-0"



238 DEVELOPMENT LLC

MAKED

KLM PROPERTIES INC 101 SE 2ND PLACE, STÉ 202 GAINESVILLE, FL 32601 352 372 6172

ADCUPTECT

PGAL
791 Park of COMMERCE BLVD.
SUITE 400

SUITE 400 BOCA RATON, FLORIDA 33487 [T] 561 988 4002 [F] 561 988 3002 PGAL TBPE REG. No. F-2742

www.pgal.com consultant

PROJECT TITLE
238 UNIVERSITY

238 W. UNIVERSITY AVE.
GAINESVILLE, FL

REGISTRATION No. AR-00944 COPYRIGHT © 2016


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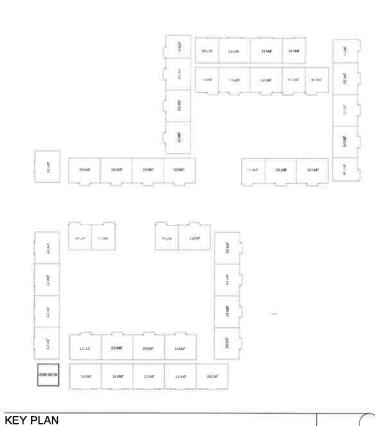
1002712.00
CURRENT DOCUMENT STAGE
SITE PLAN SUBMITTAL
CURRENT ISSUE DATE
08/16/16

SHEET TITLE
ARCHITECTURAL SITE PLAN

ET NUMBER

A1.00



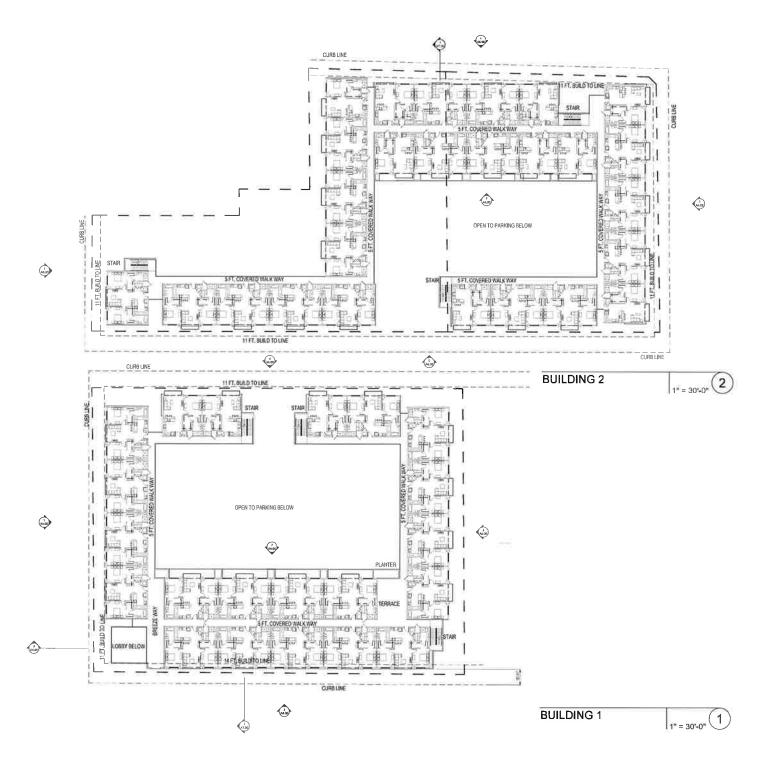


KLM PROPERTIES INC. 101 SE 2ND PLACE, STE 202 GAINESVILLE, FL 32601 352 372 6172 I Park of COMMERCE BLVD.
SUITE 400
BOCA RATON, FLORIDA 33487
[I] 561 988 4002
[F] 561 988 3002
PGAL TBPE REG. No, F-2742
www,pgal.com CONSULTANT PROJECT TITLE 238 UNIVERSITY PROJECT LOCATION 238 W. UNIVERSITY AVE. GAINESVILLE, FL REGISTRATION No. AR-0094498 COPYRIGHT @ 2016 PROJECT NUMBER 1002712.00 CURRENT DOCUMENT STAGE SITE PLAN SUBMITTAL CURRENT ISSUE DATE 08/16/16 SHEET TITLE SECOND FLOOR PLAN

A2.02

238 DEVELOPMENT LLC

SECOND FLOOR PLAN

1" = 50"-0"

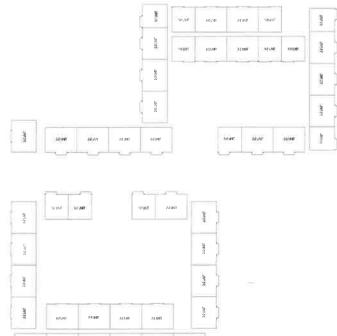

160M 350M

KEY PLAN

1" = 50"-0"

238 DEVELOPMENT LLC

KLM PROPERTIES INC 101 SE 2ND PLACE, STE 202 GAINESVILLE, FL 32601 352,372,6172

791 Park of COMMERCE BLVD. SUITE 400 BOCA RATON, FLORIDA 33487 (T) 561 988 4002 IF] 561 988 3002 PGAL TBPE REG. No. F-2742 www.pgal.com

PROJECT TITLE 238 UNIVERSITY

CONSULTANT

PROJECT LOCATION

238 W. UNIVERSITY AVE.

GAINESVILLE, FL SUBMITTAL HISTORY

FOISTRATION No. AR-000449 OPYRIGHT © 2016

PROJECT NUMBER

1002712,00 CURRENT DOCUMENT STAGE SITE PLAN SUBMITTAL

CURRENT ISSUE DATE 08/16/16

SHEET TITLE THIRD - FIFTH FLOOR PLANS

A2.03

THIRD - FIFTH FLOOR PLANS

1" = 30'-0"

CONSULTANT

PROJECT TITLE
238 UNIVERSITY

PROJECT LOCATION

238 W. UNIVERSITY AVE. GAINESVILLE, FL

SUBMITTAL HISTORY

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PROJECT NUMBER

1002712.00


CURRENT DOCUMENT STAGE

SITE PLAN SUBMITTAL

SITE PLAN SUBMITTA
CURRENT ISSUE DATE
08/16/16

ROOF PLAN

A2.04

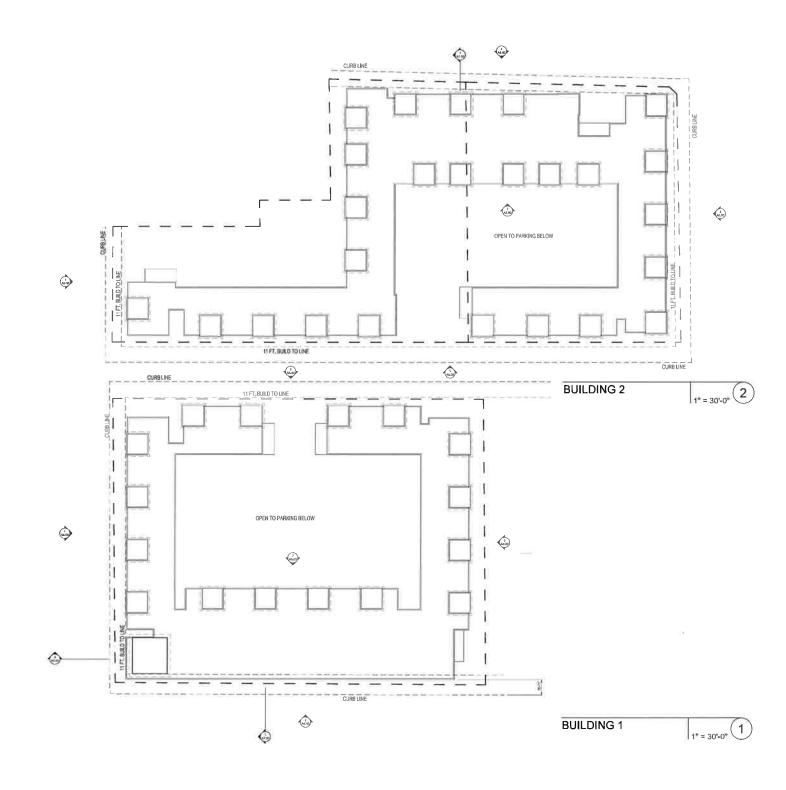

238 DEVELOPMENT LLC

OWNER

KLM PROPERTIES INC. 101 SE 2ND PLACE, STE 202 GAINESVILLE, FL, 32601 352 372 6172

PGAL

Far of Commerce BLVD.
SUITE 400
BOCA RATON, FLORIDA 33487
[T] 561 988 4002
[F] 561 988 3002
PGAL TBPE REG. No. F-2742
www.pgal.com

CONSULTANT

PROJECT TITLE
238 UNIVERSITY

PROJECT LOCATION

238 W. UNIVERSITY AVE.

GAINESVILLE, FL

SUBMITTAL HISTORY

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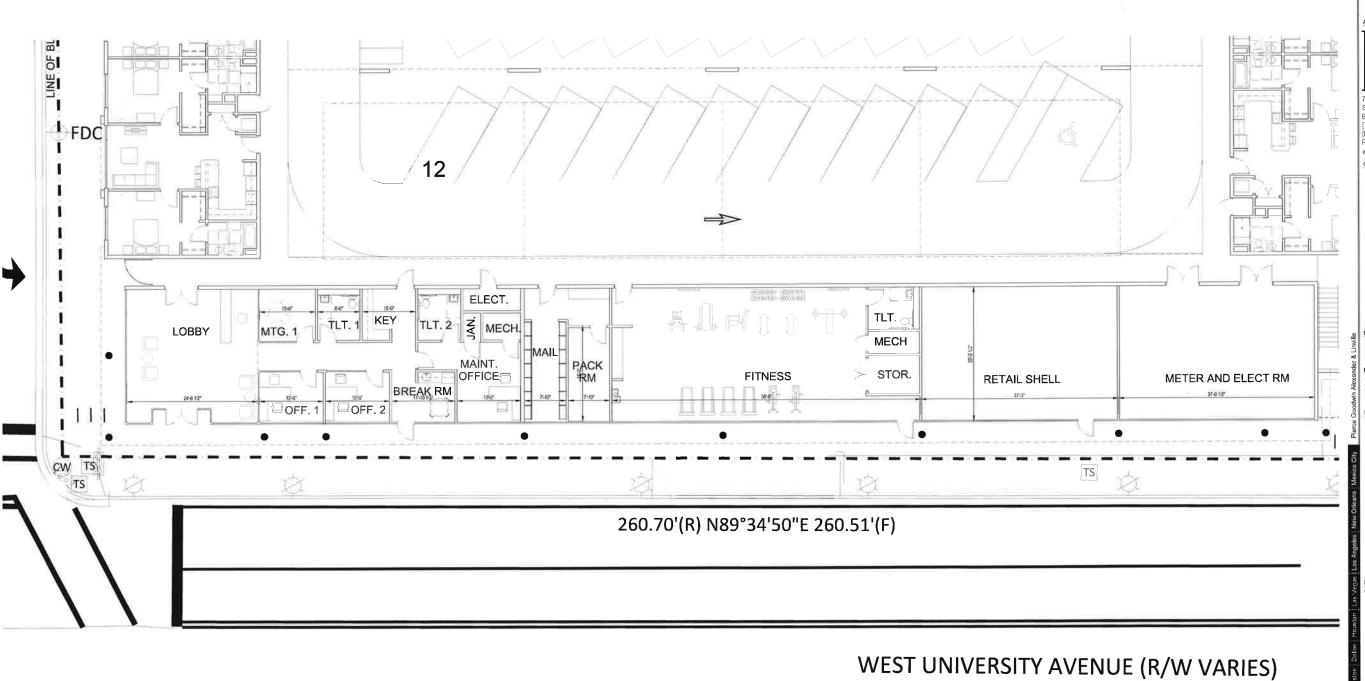
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1002712,00
CURRENT DOCUMENT STAGE
SITE PLAN SUBMITTAL
CURRENT ISSUE DATE

08/16/16 SHEET TITLE

UNIT FLOOR PLANS

A4.00



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CONSULTANT

238 UNIVERSITY

238 W. UNIVERSITY AVE. GAINESVILLE, FL

REGISTRATION No. AR-0094498 YRIGHT@ 2016


ROJECT NUMBER

1002712.00 CURRENT DOCUMENT STAGE SITE PLAN SUBMITTAL

CURRENT ISSUE DATE 08/16/16

SHEET TITLE ENLARGED GROUND FLOOR PLAN

A4.01

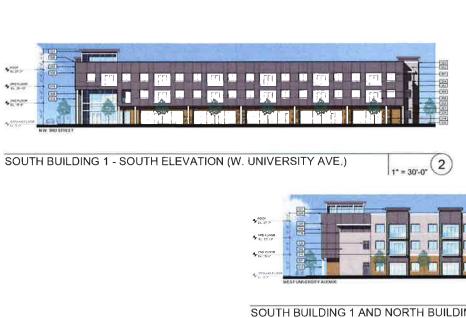

KEY PLAN

Name of





THIN BRICK VENEER LIGHT

GRAPHIC LEGEND

SOUTH BUILDING 1 AND NORTH BUILDING 2 - WEST ELEVATION (NW 3RD STREET)



SOUTH BUILDING 1 AND NORTH BUILDING 2 - EAST ELEVATION (NW 2ND STREET)

SOUTH BUILDING 2 - NORTH ELEVATION (NW 2ND AVE.)

(4 1" = 30'-0"

1" = 30'-0" 3



NORTH BUILDING 2 - SOUTH ELEVATION (NW 1ST AVE.)

1" = 30'-0" 5

1" = 30'-0" 6



SOUTH BUILDING 1 - NORTH ELEVATION (NW 1ST AVE.)

98 N.80*

SOUTH BUILDING 1 - NORTH INTERIOR CAR PARK ELEVATION









A6.00C

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KLM PROPERTIES INC 101 SE 2ND PLACE, STE 202 GAINESVILLE, FL 32601

352 372 6172

791 Park of COMMERCE BLVD. SUITE 400 BOCA RATON, FLORIDA 33487



BUILDING SECTIONS 11" = 30"-0" 1

238 DEVELOPMENT LLC

OWN

KLM PROPERTIES INC. 101 SE 2ND PLACE, STE 202 GAINESVILLE, FL 32601 352,372,6172

ARCHITECT

PGAL

N. Park of COMMARGE E BLVD

791 Park of COMMERCE BLVD. SUITE 400 BOCA RATON, FLORIDA 33487 [T] 561 988 4002 [F] 561 988 3002 PGAL TBPE REG. No. F-2742 www.pgal.com COMSULTANT

PROJECT TITLE

238 UNIVERSITY

238 W. UNIVERSITY AVE. GAINESVILLE, FL

SUBMITTAL HISTORY

2 SITE PLAN RE SUBMITTAL 04/19/16

4 TECH REVIEW COMMENTS 06/02/1

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1002712.00 CURRENT DOCUMENT STAGE SITE PLAN SUBMITTAL

CURRENT ISSUE DATE 08/16/16

BUILDING SECTIONS


A7.00

0 15" 30" 60" SCALE: I" = 30'-0"



EXTERIOR RENDERING LOOKING NORTHWEST FROM WEST UNIVERSITY AVE

N.T.S. (2)

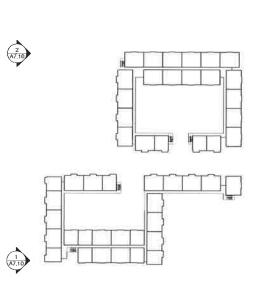

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CONSULTANT

238 UNIVERSITY

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1002712.00 SITE PLAN SUBMITTAL

CURRENT ISSUE DATE 08/16/16 SHEET TITLE

EXTERIOR RENDERINGS

A7.10

KEY PLAN

123

EXTERIOR RENDERING LOOKING NORTHEAST FROM WEST UNIVERSITY AVE