

R905.1.1 UNDERLAYMENT. UNLESS OTHERWISE NOTED UNDERLAYMENT FOR ASPHALT SHINGLES, METAL ROOF SHINGLES, MINGRAL—SURFACED ROLL ROOFING, SLATE AND SLATE—TYPE SHINGLES, WOOD SHINGLES, WOOD SHAKES AND METAL ROOF PANELS SHALL CONFORM TO THE APPLICABLE STANDARD SUSTED IN THIS CHAPTER. UNDERLAYMENT MATERIALS REQUIRED TO COMPLY WITH ASTM D226, D1970, D4869 AND D6757 SHALL BEAR A LABEL INDICATING COMPLANCE TO THE STANDARD DESIGNATION AND, IF APPLICABLE, TYPE CLASSIFICATION INDICATED IN TABLE R905.1.1. UNDERLAYMENT SHALL BE APPLIED AND ATTACHED IN ACCORDANCE WITH TABLE R905.1.1. EXCEPTION: A REINFORCED SYNTHETIC UNDERLAYMENT TOMPLYING WITH ASTM D226 TYPE II AND HAVING A MINIMUM TEAR STRENGTH IN ACCORDANCE WITH ASTM D1970 OR ASTM D4533 OF 20 POUNDS SHALL BE PERMITTED. THIS UNDERLAYMENT SHALL BE INSTALLED AND ATTACHED IN ACCORDANCE WITH THE UNDERLAYMENT ATTACHMENT METHODS OF TABLE R905.1.1 FOR THE APPLICABLE ROOF COVERING AND SLOPE, EXCEPT METAL CAP NAILS SHALL BE REQUIRED WHERE THE ULTIMATE DESIGN WIND SPEED, V _{ULT} , EQUILES OR EXCEEDS 150 MPH.	ROOF SHEATHING / NAILING ZONES ROOF SHEATHING SHALL BE MADE OF PLYWOOD (WOOD STUCTURAL PANELS), OSB PLYWOOD SHEATHING OR BETTER. SHEATHING SHALL BE FASTENED TO ROOF FRAMING W/ 8d RING SHANK FULL HEAD NAILS @ 6" O.C. @ EDGES AND 6" O.C. AT INTERMEDIATE FRAMING. ROOF FLASHING SHALL BE NOT LESS THAN 26 GAGE 0.0179 INCHES CORROSION—RESISTANT SHEET METAL (TABLE R903.2.1) AND SHALL EXTEND 10 INCHES FROM THE CENTERLINE EACH WAY FOR ROOFS HAVING SLOPES LESS THAN 12 UNITS VERTICAL IN 12 UNITS HORIZONTAL, AND 7 INCHES FROM THE CENTERLINE EACH WAY FOR SLOPES OF 12/12 AND GREATER. FLASHING SHALL HAVE AN END LAP OF NOT LESS THAN 4 INCHES. R905.2.8.2 VALLEYS. VALLEY LININGS SHALL BE INSTALLED IN ACCORDANCE WITH THE MANUFACTURER'S INSTRUCTIONS BEFORE APPLYING SHINGLES. VALLEY LINING SOF THE FOLLOWING TYPES SHALL BE PERMITTED: 1. FOR OPEN VALLEYS (VALLEY LINING EXPOSED) LINED WITH METAL. THE VALLEY LINING SOF THE FOLLOWING TYPES SHALL BE PERMITTED. THE CORRO—SION—RESISTANT METALS IN TABLE R903.2.1. 2. FOR OPEN VALLEYS, VALLEY LINING OF TWO PILES OF MINERAL—SURFACED ROLL ROOFING, COMPLYING WITH ASTM D3390 OR ASTM D6380 CLASS M, SHALL BE PERMITTED. THE BOTTOM LAYER SHALL BE 18 INCHES (457 MM) AND THE TOP LAYER NOT LESS THAN 36 INCHES (914 MM) WIDE. 3. FOR CLOSED VALLEYS (VALLEY COVERED WITH SHINGLES), VALLEY LINING OF ONE PLY OF SMOOTH ROLL ROOFING COMPLYING WITH ASTM D6380 CLASS S AND NOT LESS THAN 36 INCHES WITH ASTM D6380 CLASS S AND NOT LESS THAN D1970 SHALL BE PERMITTED. SELF—ADHERING POLYMER MODIFIED BITUMEN UNDER—LAYMENT COMPLYING MATERIAL.	2017 ROOF PLAN NOTES

BE ED DS	. Z		76		OF
A NEW MODEL HOME FOR:		NEIGHBORHOOD	BLOCK	LOT	CLOSING DATE:
Heart Wood Model 5-B			1		2/9/2018 — INITIAL PRELIMINARY 2/16/2018 — CHANGED FRONT ELEVATION 3/13/2018 — WORKING DRAWINGS STARTED
MODEL CALL OUT:	ELEVATION CALL OUT				STANTED
drawn by: D.M.G./A.M.D.	I.P.C. SERVICES JOB NUMBER 18121	TYPICAL SCALE: 1/4" =	= 1;	-0 "	





MALL BE DESIGNED AND CONSTRUC ASSEMBLY BY PRO-VIDING A WATI 4 R703.2 AND A MEANS OF DRAIN IST CONDENSATION IN THE EXTERN HIS CODE.


p.c. services job number 18121


D.M.G./A.M.D

PICAL SCALE: 1/4

=

Agency

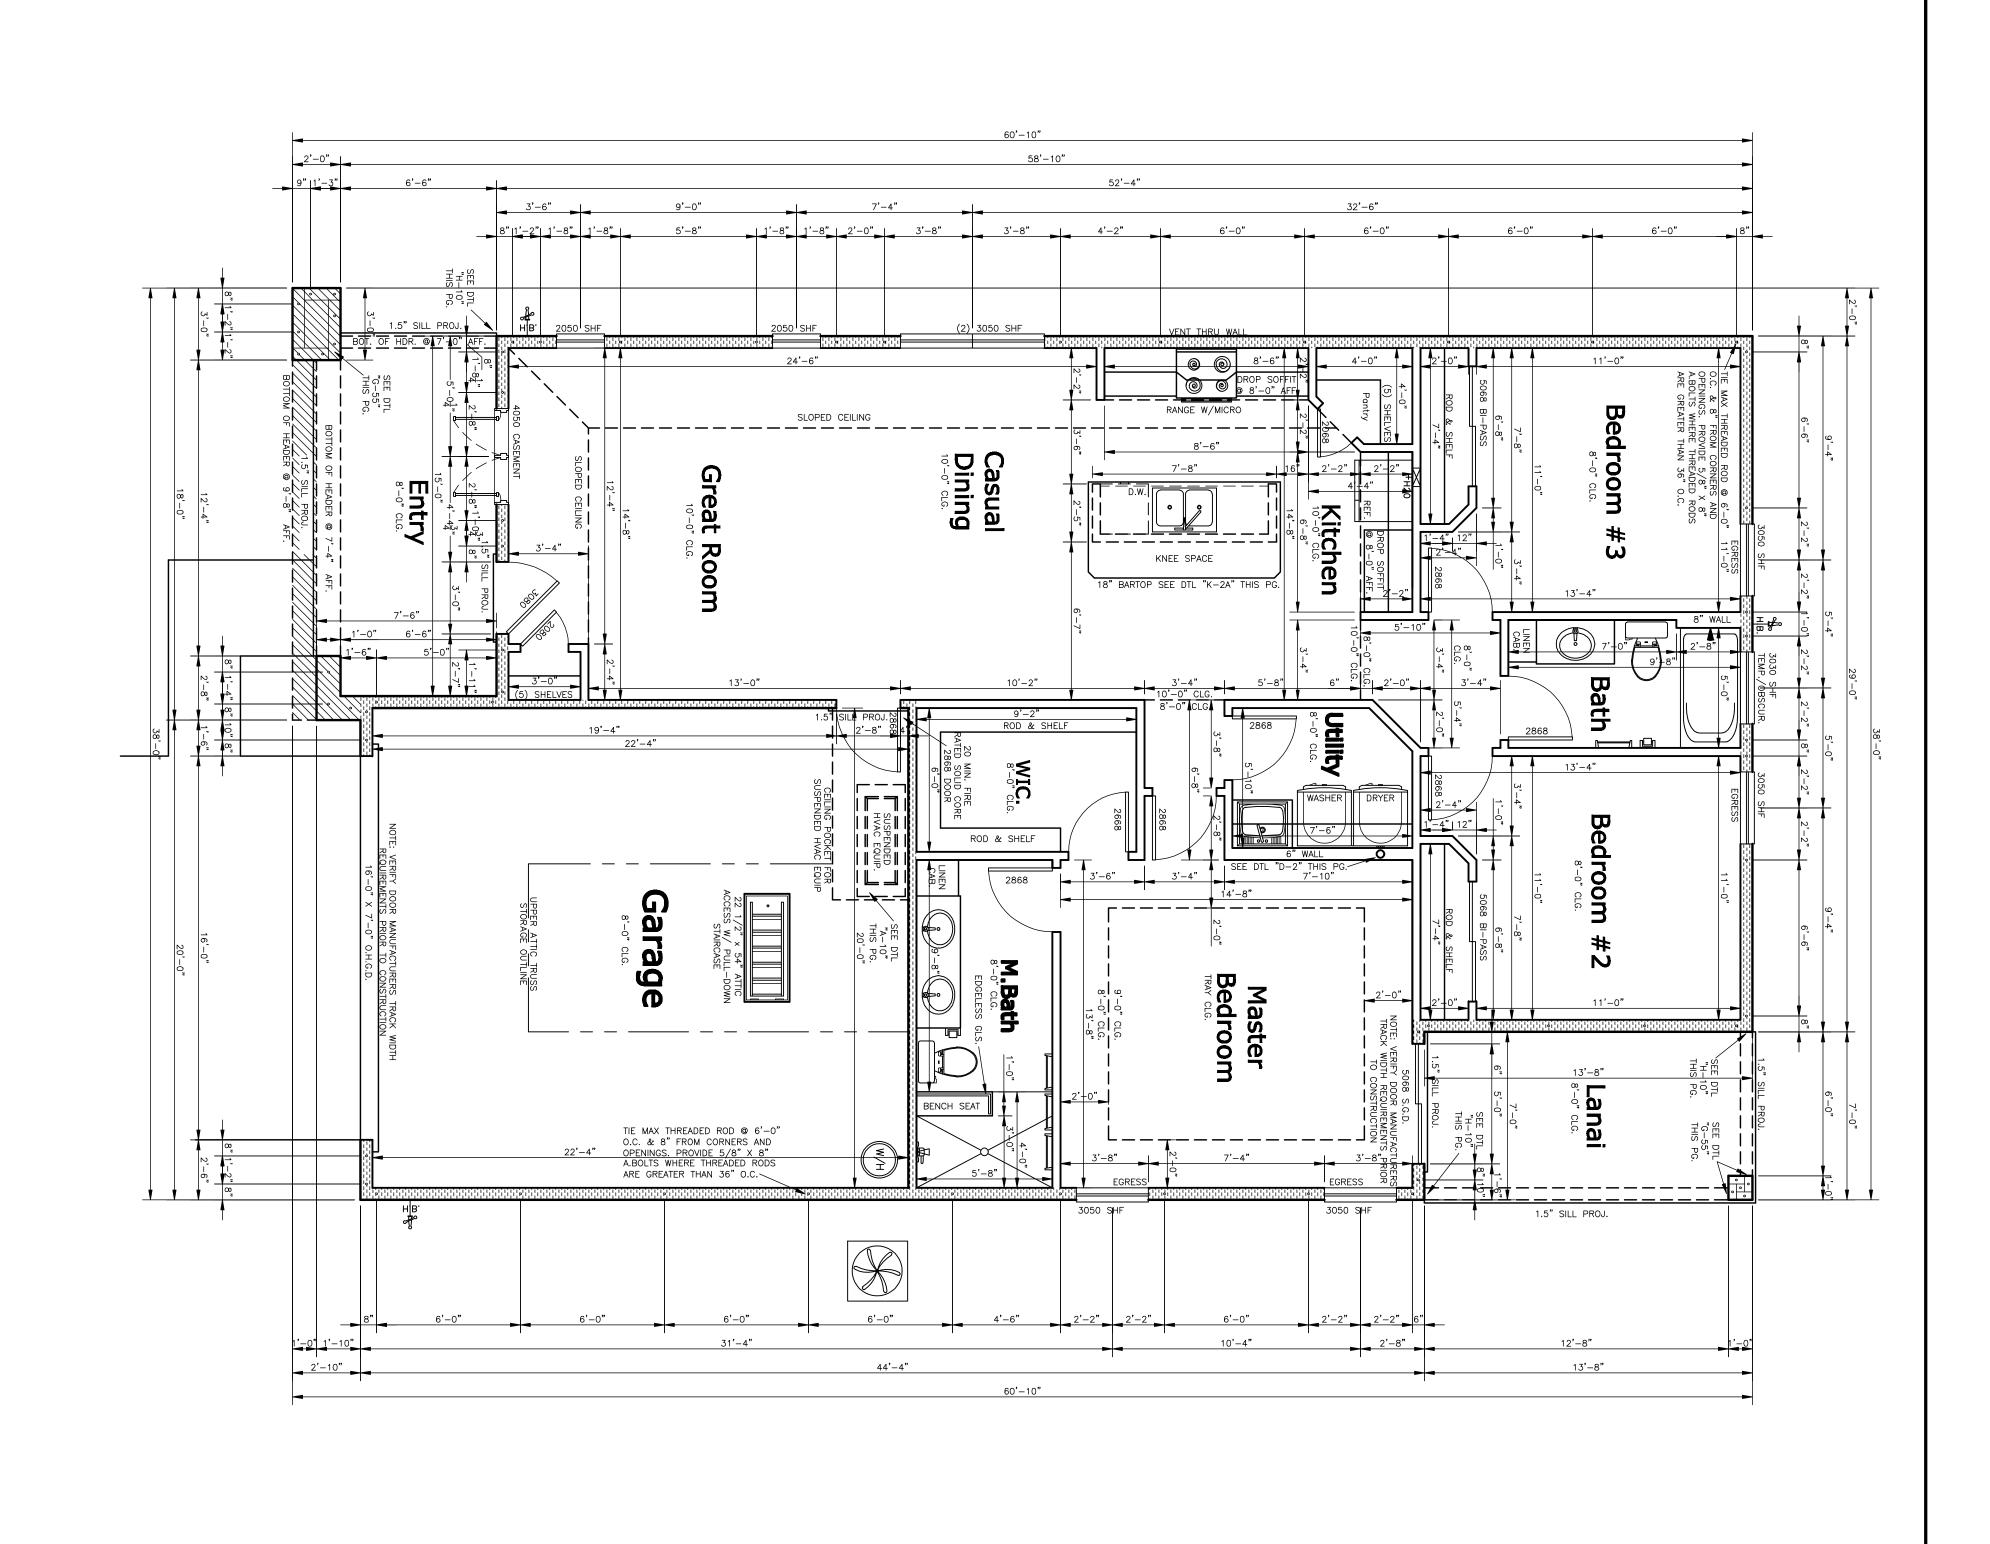

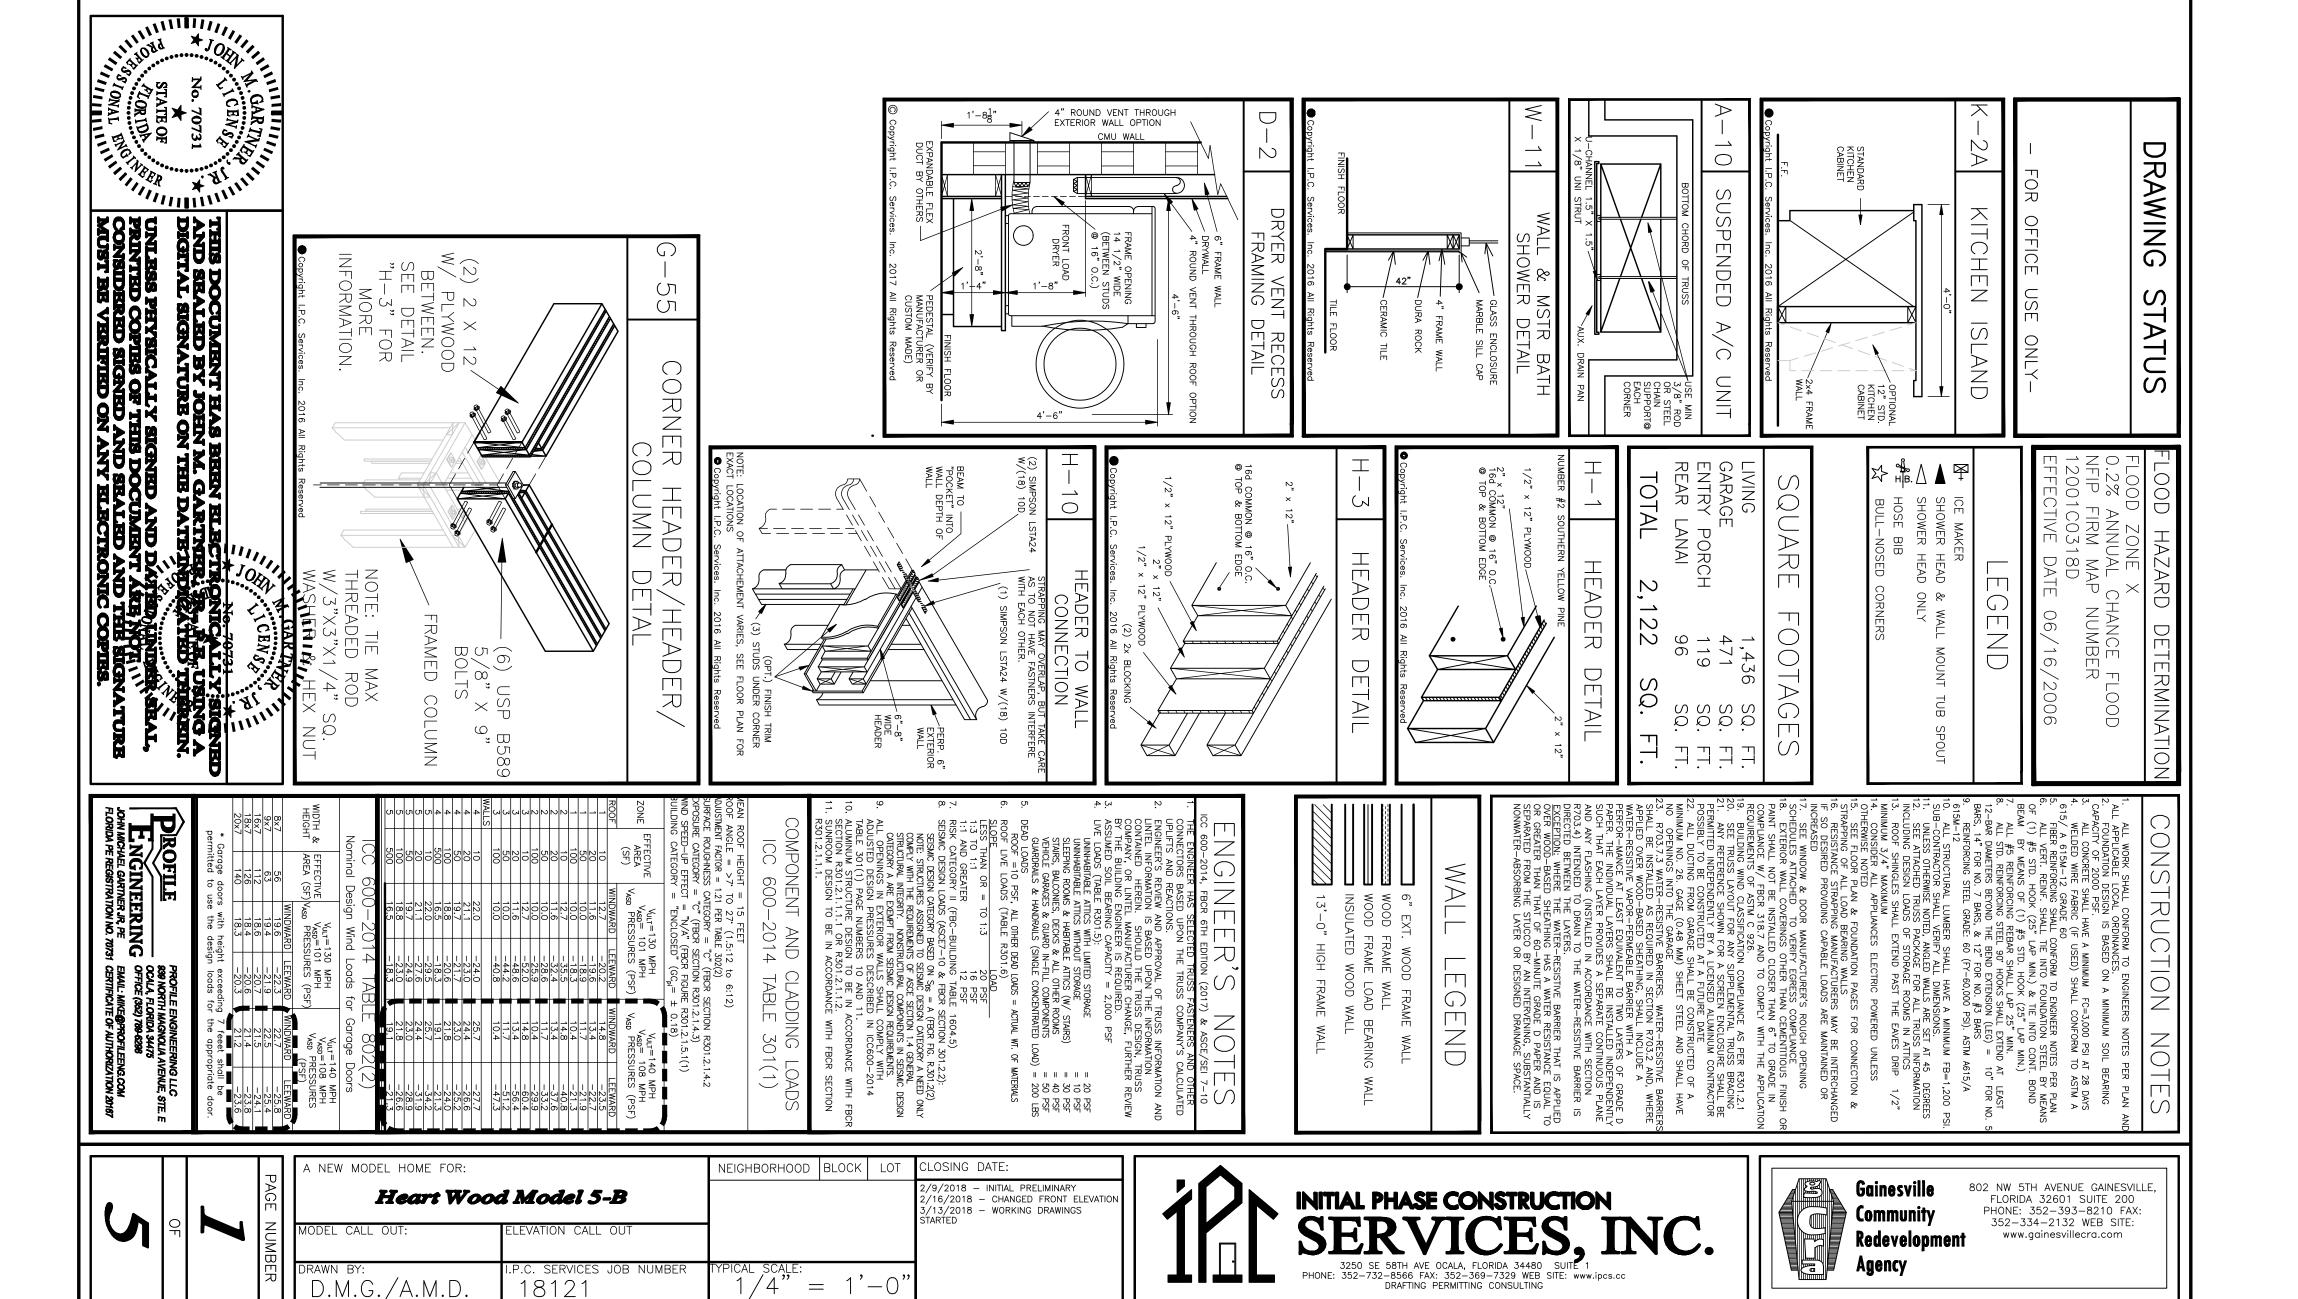



P.C. SERVICES JOB NUMBER

=

<u>18</u>121


D.M.G./A.M.D

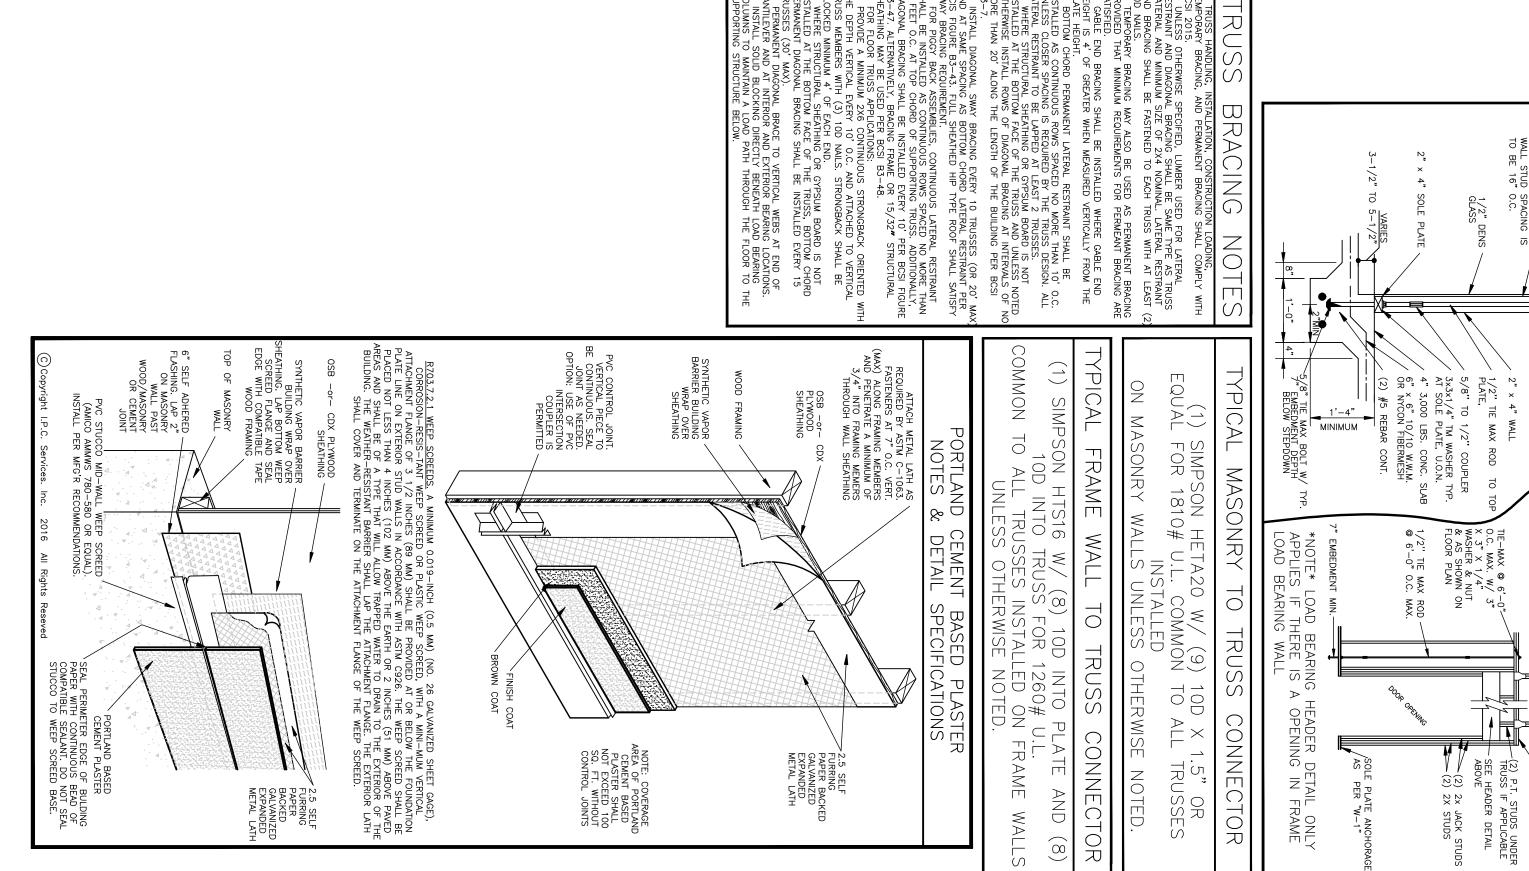

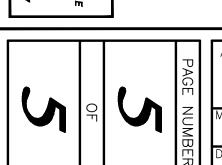

CARTAIN OF STRAIN OF STRAI

ENGINEERING
JOHN MICHAEL GARTNER JR. PE
FLORIDA PE REGISTRATION NO. 70731

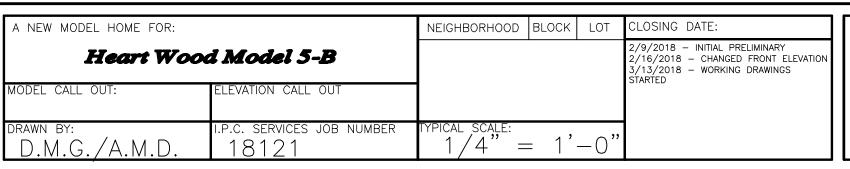



 \otimes



SEE TRUSS LAY FOR SPECIFIC STRAPPING

(1) SIMPSON MTS16 COMMON TO ALL TRUSSES INSTALLED ON FRAME WALLS UNLESS OTHERWISE NOTED.


1/2" TIE MAX ROD @ 6'.
O.C. MAX. AND 8" FROM
EVERY CORNER

3x3x1/4" TM WASHER AT SOLE PLATE, U.O.N.

INTERIOR BEARING

WALL SECTION

(2) 2"X4" DOUBLE TOF PLATE OF SYP #2

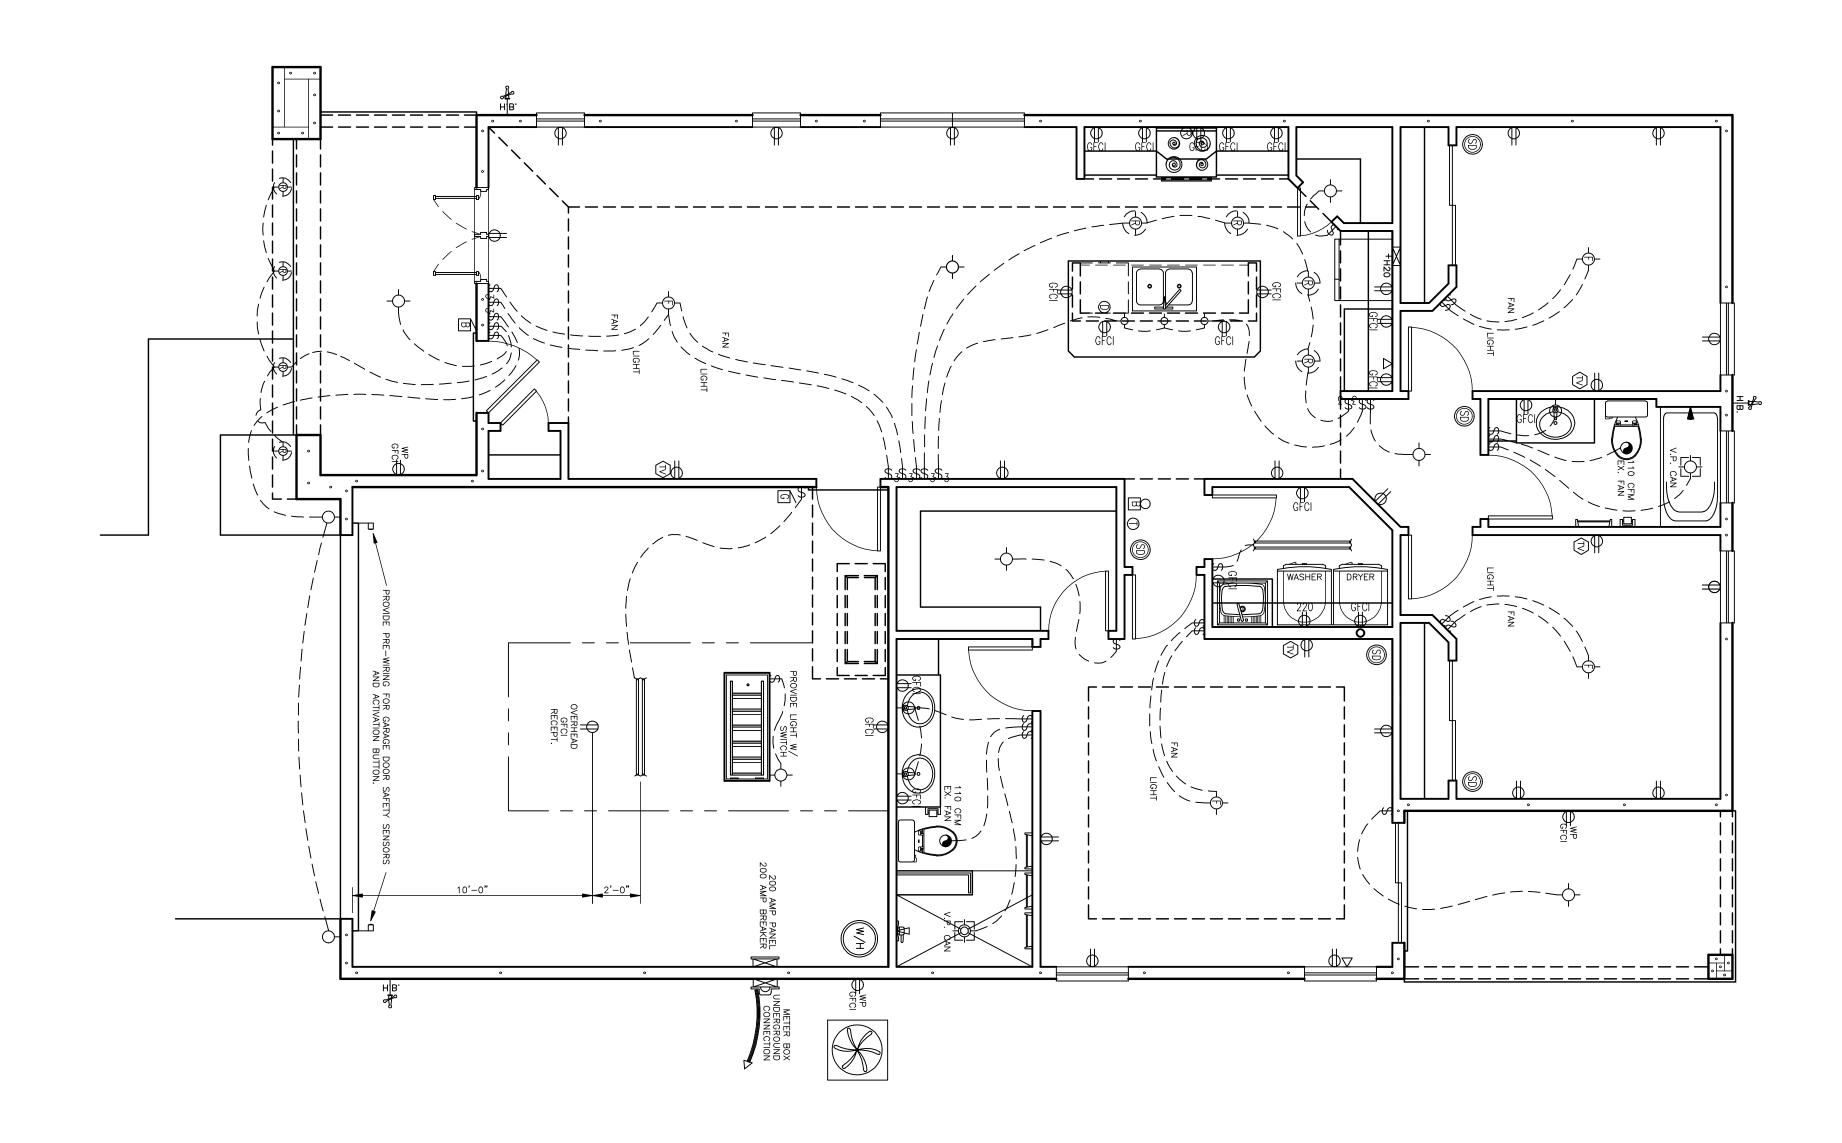

OMERHED USHT FIXILIE

OMERHED INN BOX

RECESSED USHT FIXILIE

RECESSED EVENUL BY LIGHT

CAN MY USHT & FAN

WALL MOUNTED USHT FIXILIE

WALL MOUNTED USHT FIXILIE

WALL MOUNTED USHT FIXILIE

WALL MOUNTED USHT FIXILIE

WALL MOUNTED PROOF RECEPTACE

WALL MOUNTED USHT FIXILIE

WALL MOUNTED PROOF RECEPTACE

WALL MOUNTED PROOF RECEPTACE

WALL MOUNTED PROOF RECEPTACE

WALL MOUNTED PROOF RECEPTACE

CON RECEPTACE

RENDES SHEET SHEET (HOME RAIN)

DESHAWASHER SUPPLY (HOME RAIN)

CONDESSED TO BEEL BUITON

CEDITAL WALL SMITCH

RELEPHONE

RELEPHONE

RELEPHONE

RELEPHONE

RELEPHONE

CEDITAL WALL SMITCH

STERED LOCATION (WRE START)

STERED LOCATION (WRE START)

STERED LOCATION (WRE START)

STERED LOCATION (WRE START)

CEDITAL WALL SMITCH

STERED LOCATION (WRE START)

STERED LOC

A NEW MODEL HOME FOR:

Heart Wood Model 5-B

MODEL CALL OUT:

DRAWN BY:

D.M.G./A.M.D.

A NEW MODEL HOME FOR:

NEIGHBORHOOD BLOCK LOT CLOSING DATE:

2/9/2018 - INITIAL PRELIMINARY
2/16/2018 - CHANGED FRONT ELEVATION
3/13/2018 - WORKING DRAWINGS
STARTED

1/4" = 1'-0"



